

#### Legend

- MAJOR CONTOUR - PROPOSED
- MINOR CONTOUR - PROPOSED
- MAJOR CONTOUR - EXISTING
- MINOR CONTOUR - EXISTING
- FENCE - EXISTING
- FENCE - PROPOSED



## ANIMAS GLACIER GRAVEL PIT WEEMINUCHE CONSTRUCTION AUTHORITY

#### General Notes:

All materials and workmanship shall be in accordance with the La Plata County design standards. When requirements in the construction specifications or design standards conflict the more stringent requirement shall apply.

The contractor is responsible for obtaining all required permits prior to the commencement of any work on the project.

An Excavation Permit for Work in the Public Ways is required for all work in the public right-of-way.

The contractor shall be responsible for notifying the developer of any problems in conforming to the approved plans for any element of the proposed improvements prior to its construction.

The developer shall be responsible during construction activities to resolve construction problems due to changed conditions or design errors encountered by the contractor during the course of any portion of the proposed work. In the opinion of the construction observer any modification proposed by the developer to the approved plans involving significant changes to the character of the work or to future contiguous public or private improvements, the developer shall be responsible for submitting revised plans to the appropriate agency for approval prior to any further construction related to that portion of the work. Any improvements constructed not in accordance with the approved plans or the approved revised plans, shall be removed and the improvements shall be reconstructed according to the approved plans.

The contractor shall contact the appropriate agencies for location of underground gas, electric, and telephone utilities at least 48 hours prior to commencement of construction.

The contractor shall be responsible for providing a copy of "RECORD DRAWING" plans to the appropriate agencies prior to final acceptance of work.

The contractor shall notify the construction observer at least 24 hours prior to desired inspection.

The contractor shall reset all Survey Monuments disturbed during construction within 60 days of project completion.

The contractor shall be safely and completely responsible for conditions at and adjacent to the job site, including safety of all persons and property during performance of the work. This requirement shall apply continuously and not be limited to normal working hours.


The duty of the County to conduct construction review of the contractor's performance is not intended to include review of the adequacy of the contractor's safety measures in, on, or near the construction site.

Field conditions may exist that require changes to the drawings. If such conditions are encountered, standard engineering practices shall be followed.

#### Street Construction Notes:

The contractor shall provide all lights, signs, barricades, flagmen or other devices necessary to provide for public safety in accordance with the current Manual on Uniform Traffic Control Devices.

The contractor shall provide ingress and egress to private property adjacent to the work throughout the period of construction and prior to beginning work shall obtain written agreement from the affected property owners impacted by this access.

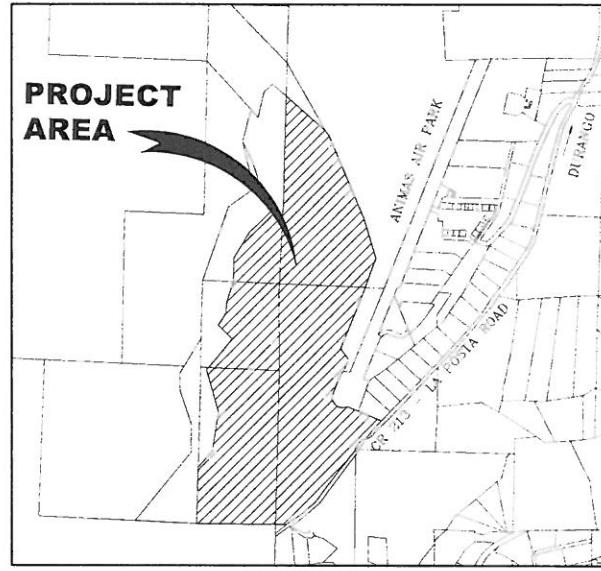

VICINITY MAP

24x36 1" = 500'  
11x17 1" = 1000'

#### Grading and Drainage Notes:

Grading shown is for rough grading only. Changes may be necessary to bring plan into conformance with approved Final Drainage Plan and Site Plan.

A water truck, if called for by the construction observer, will be provided to keep wind erosion in check.

Settlement of soil accumulation beyond the property boundaries or construction limits will be prevented.

Any construction debris or mud tracking in the public right-of-way shall be removed immediately by the contractor. The contractor shall immediately fix any excavations or excessive pavement failures caused by the development and shall properly barricade the site until construction is complete. Failure by the contractor to correct any of the above within 48 hours of written notice by the inspecting agency shall cause the inspecting agency to issue a stop work order and/or do the work and make a claim against the letter of credit for any cost incurred by the agency.

Areas being disturbed by the grading shall be reseeded with native vegetation or as specified in The Reclamation Plan.

A Storm Water Management plan shall be included as part of grading plans for disturbed areas greater than one-half acre.


#### SHEET INDEX

PROJECT DATA SHEET  
SITE AND GRADING PLANS  
PLAN & PROFILE  
DETAILS & TYPICAL SECTIONS  
CROSS SECTIONS

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#### Note:

The plans where checked for general conformance with La Plata County Standards. At the time of construction, field conditions may be encountered that will require additional drawings or consideration.

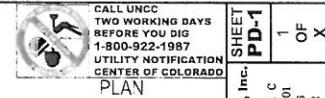

SHEET  
PD-1  
1  
OF  
X

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ANIMAS GLACIER GRAVEL PIT  
PROJECT DATA SHEET

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DRAFTED BY: [Signature]  
DATE: 05-04-2012  
REVISIONS: [Signature]

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REVISIONS:

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0-1  
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Phone: (970) 355-4046  
Fax: (970) 355-4047

**ANIMAS GLACIER GRAVEL PIT  
SITE PLAN**


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Date: 05-04-2012  
By: PEC-A-1 A. S. Civil Engineer


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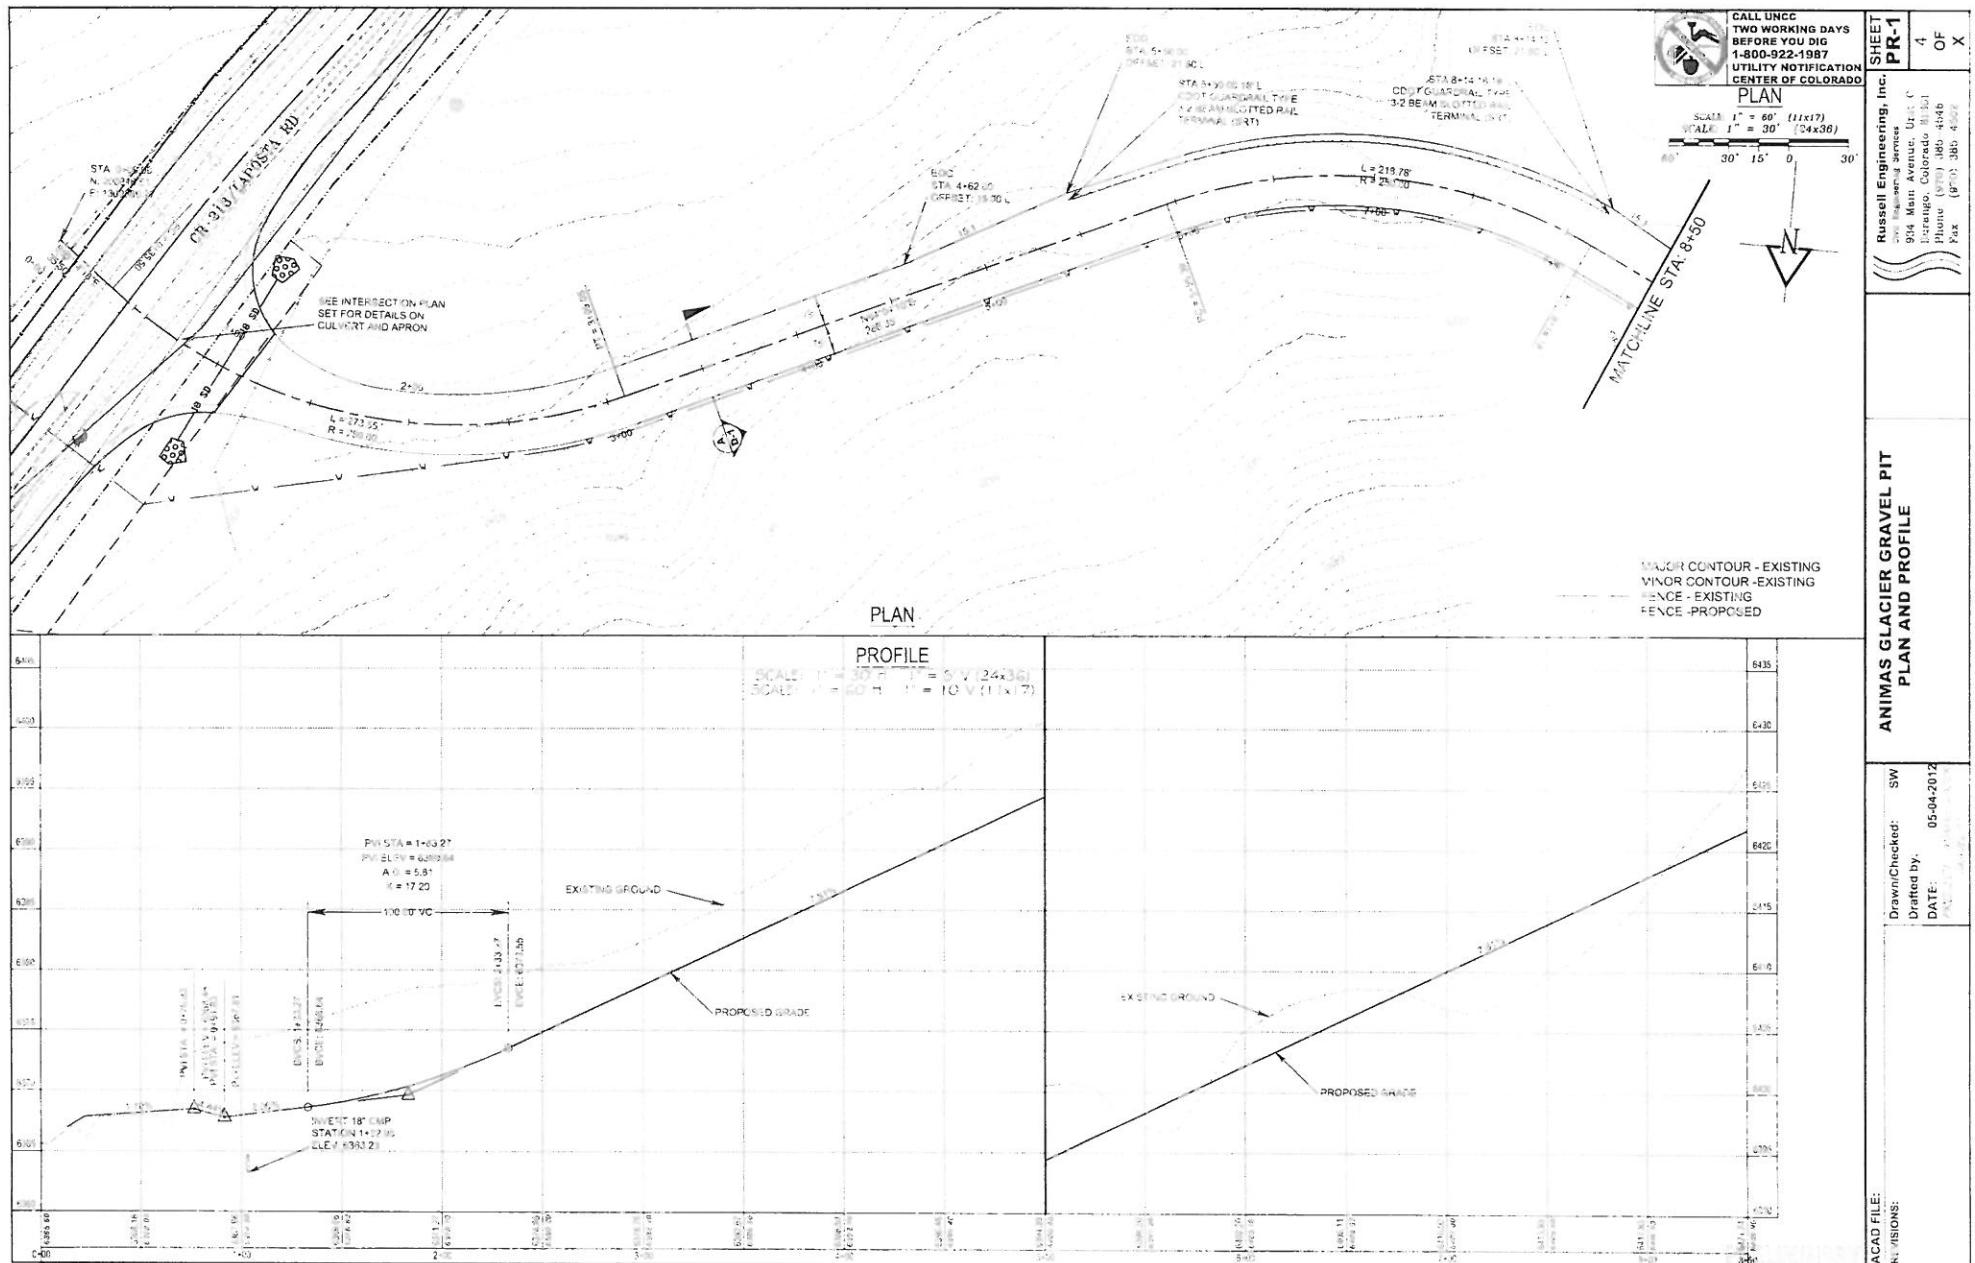
LINE TABLE		
LINE	BEARING	LENGTH
L-1	S 38°14' E	142.81'
L-2	S 12°18' W	61.85'
L-3	N 22°48' E	4.84'
L-4	S 42°36' E	104.42'
L-5	S 22°37' E	192.03'
L-6	S 22°37' E	30.28'
L-7	S 46.30' E	10.46'
L-8	S 46.30' E	53.11'
L-9	S 46.30' E	30.28'
L-10	S 46.30' E	54.70'
L-11	S 46.30' E	122.23'

**LEGEND**

- PROPERTY LINE
- - - GRAVEL PIT BOUNDARY LINE
- FLOW PATH



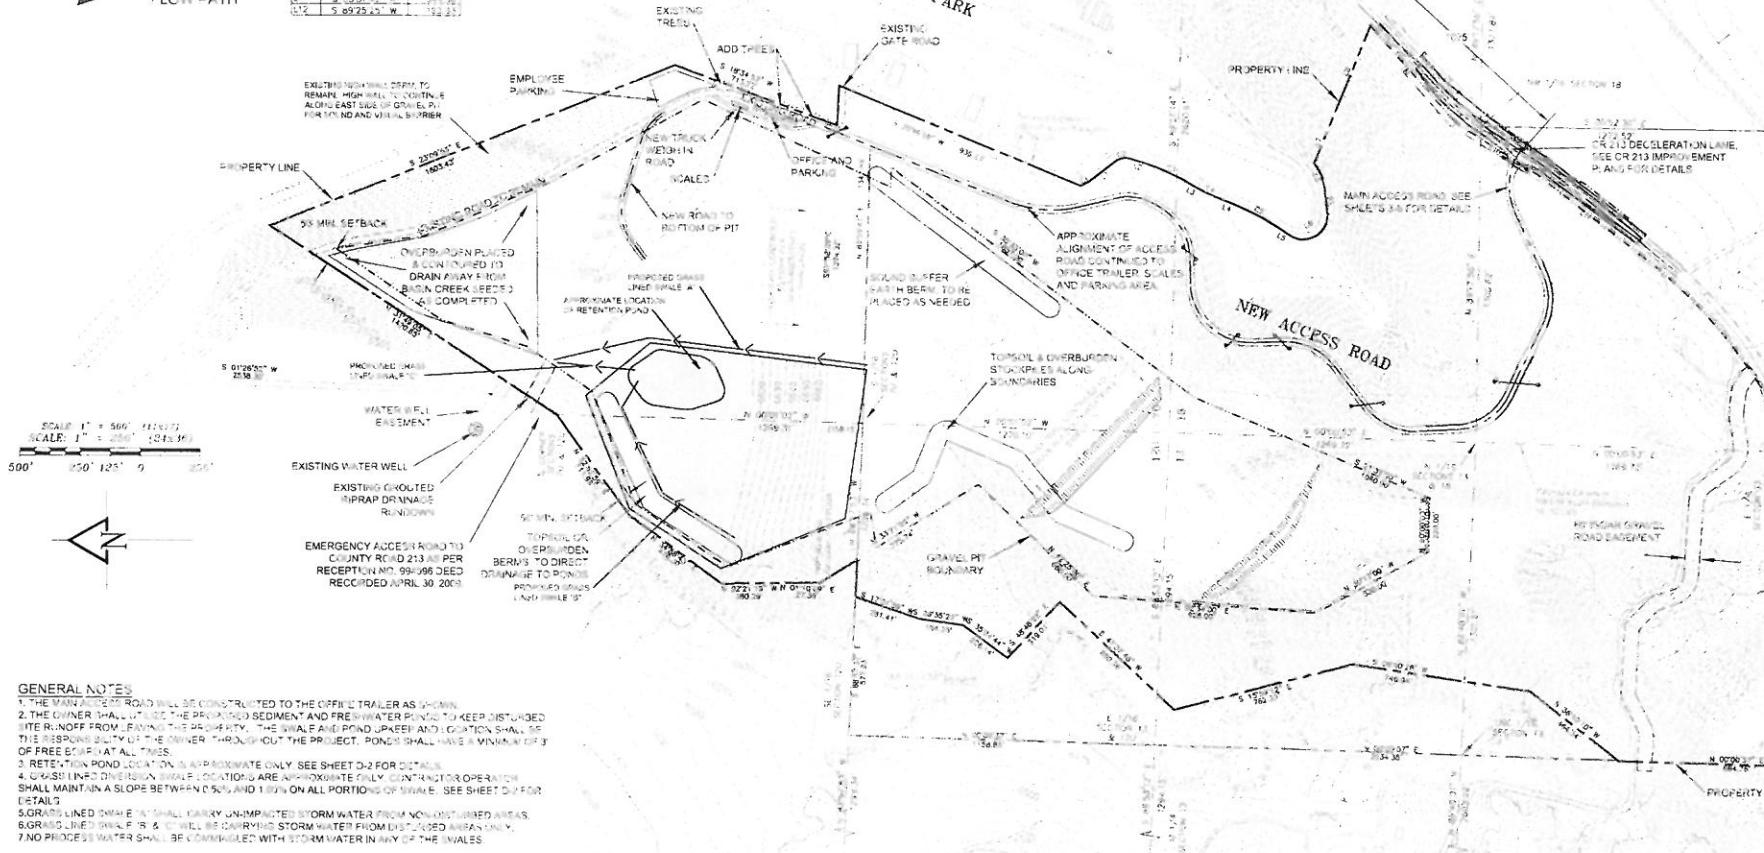

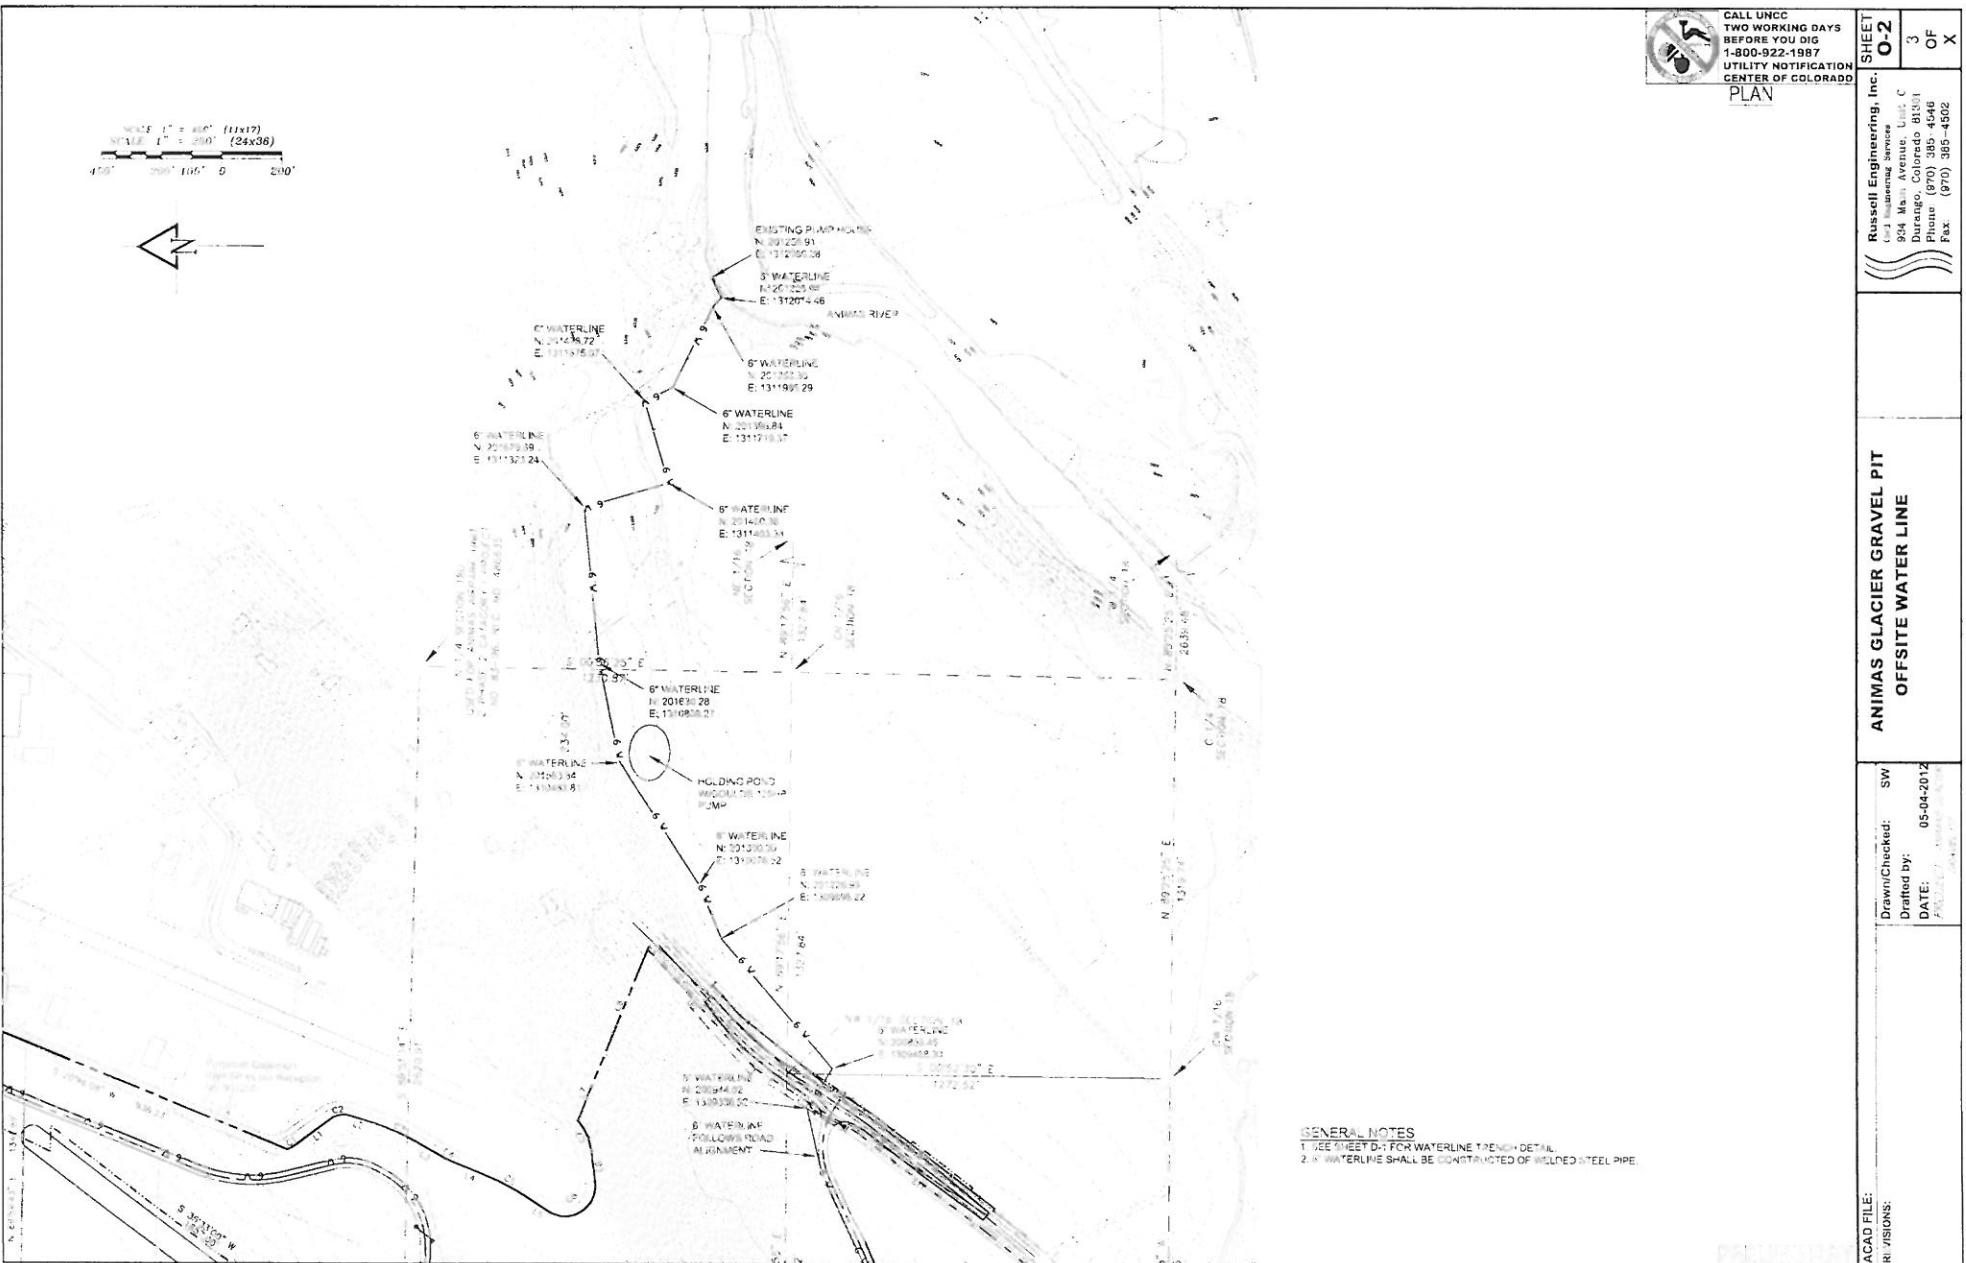

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**PLAN**


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Scale 1" = 30' (1/4x36)


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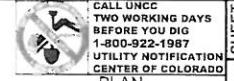
**SHEET PR-2**

5 OF X

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(970) 385-4122  
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PLAN

SCALE: 1" = 60' (1x17) (24x36)  
SCALE: 1" = 30' (1x17) (24x36)

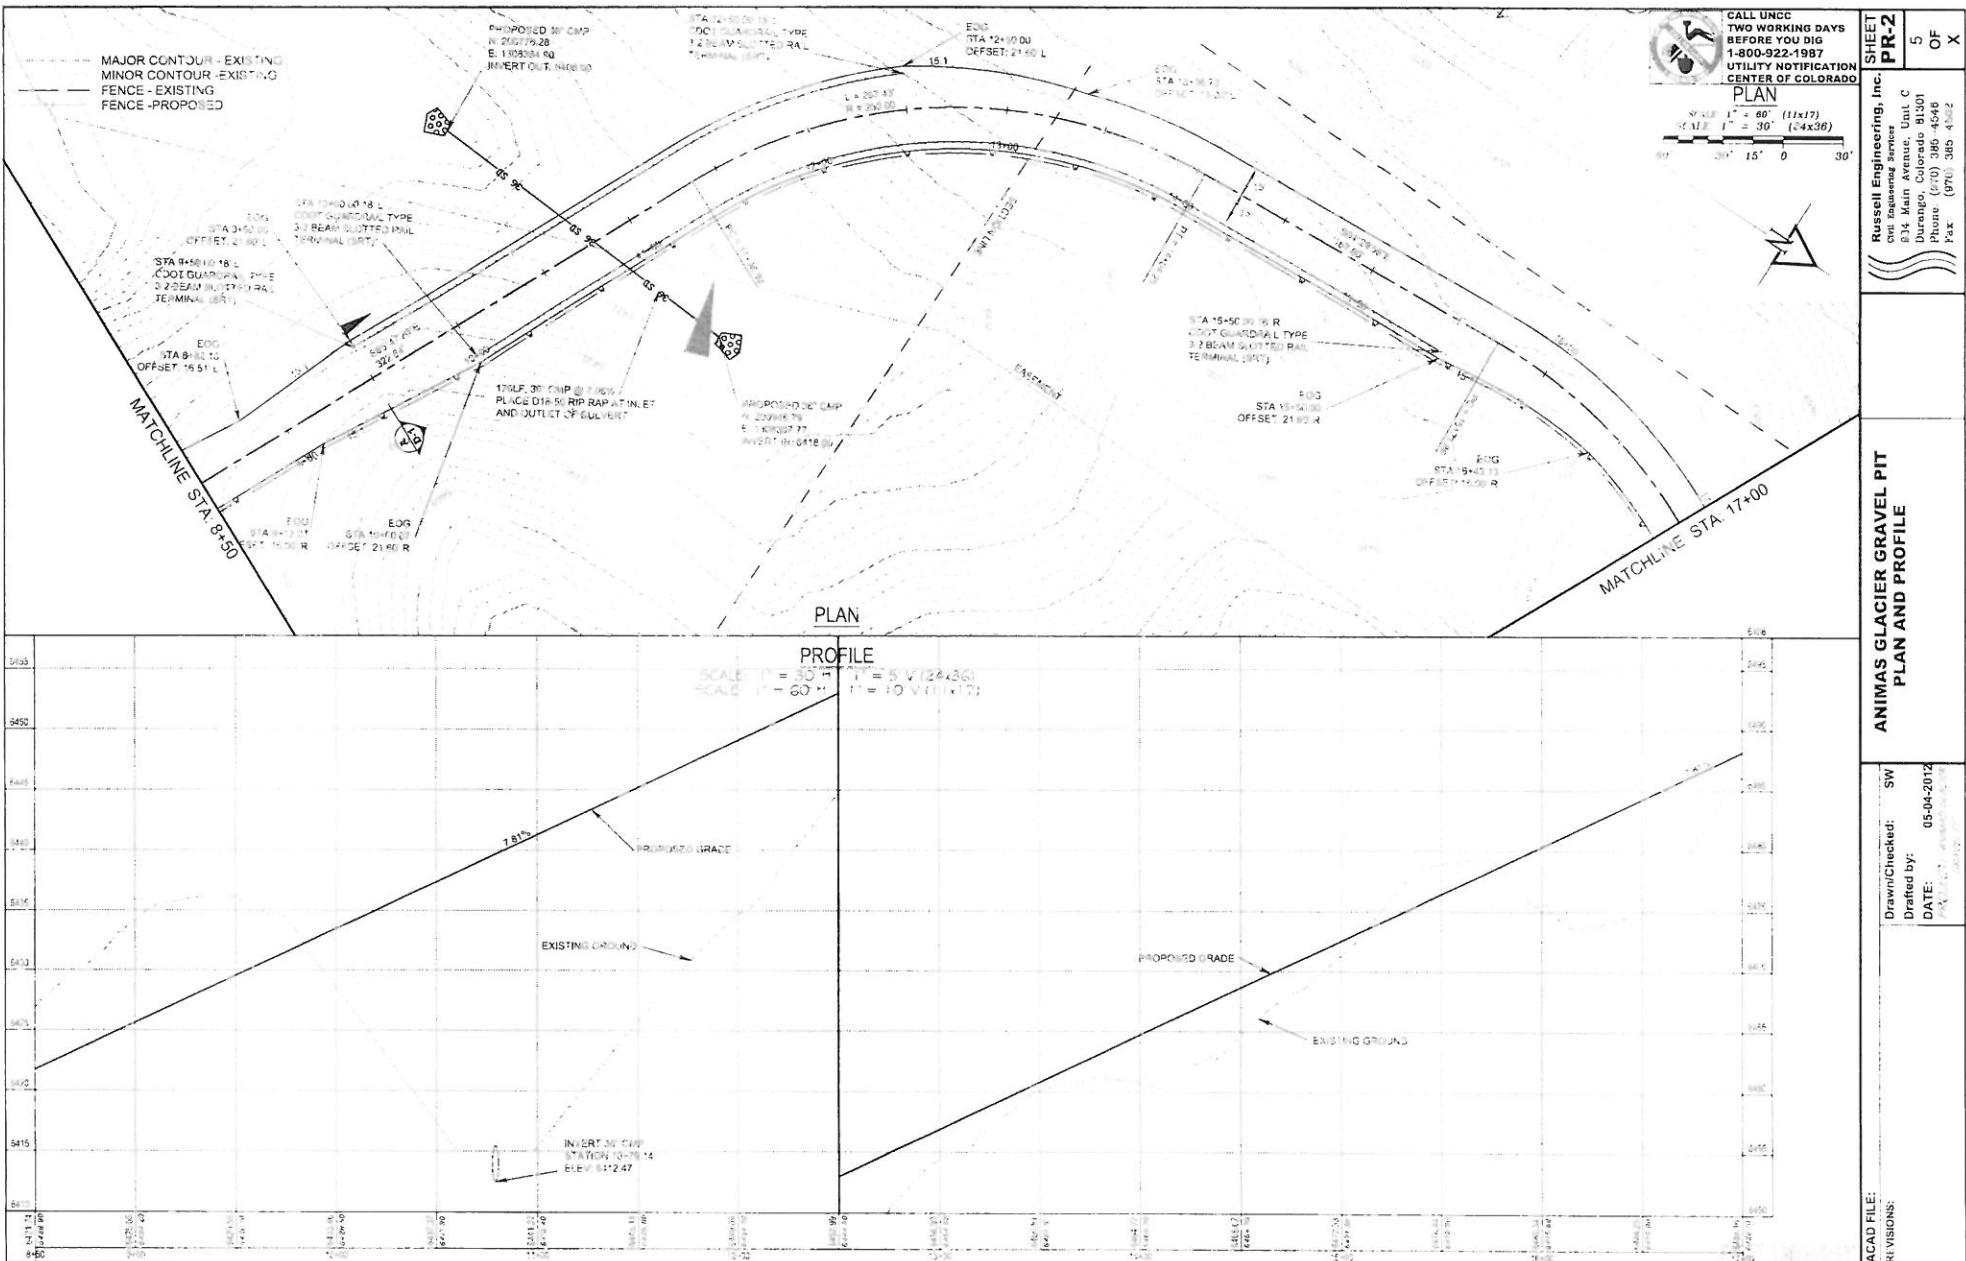69° 90° 15° 0° 30°

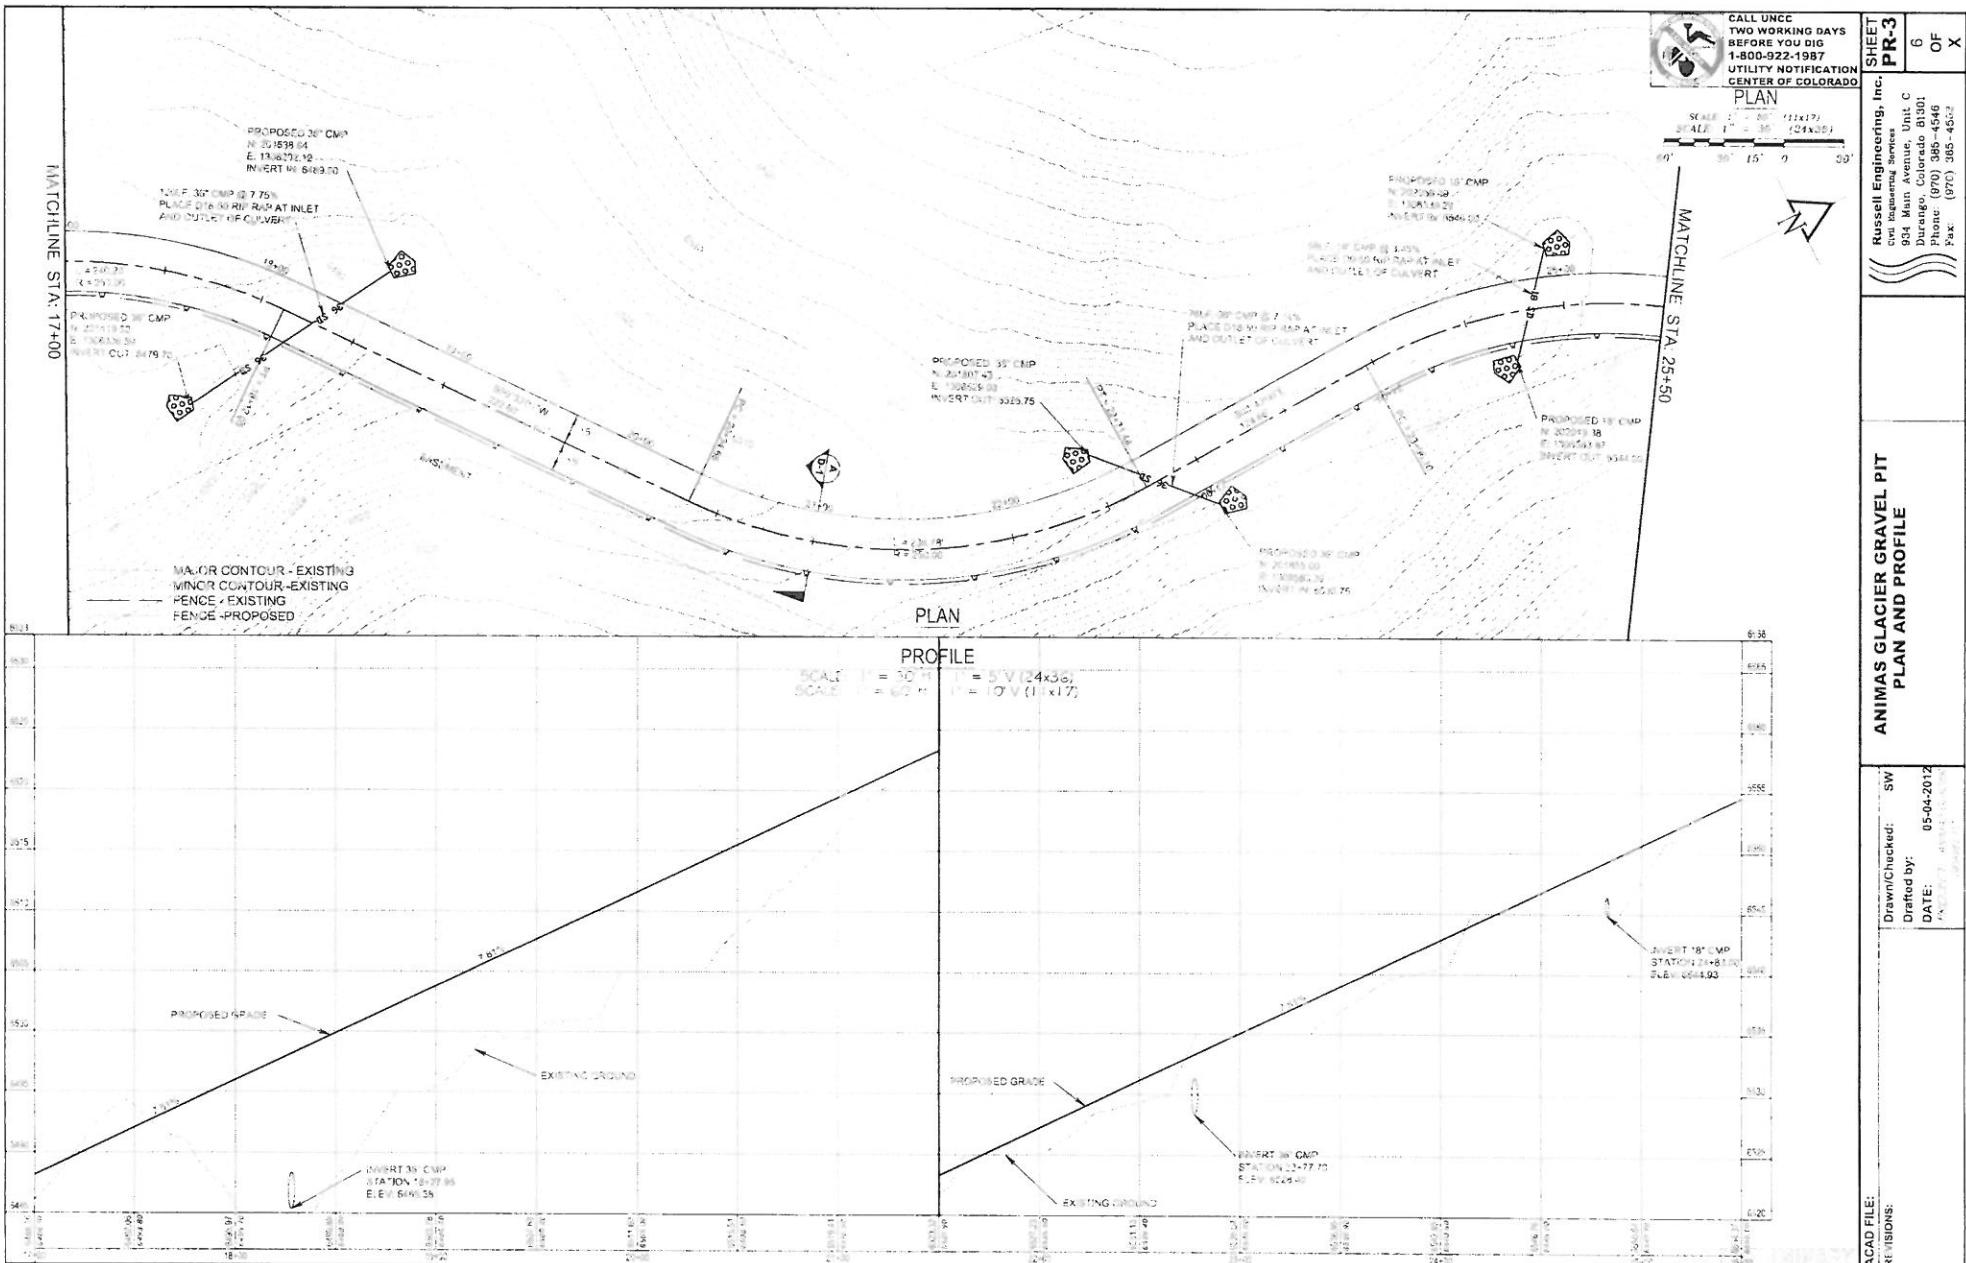
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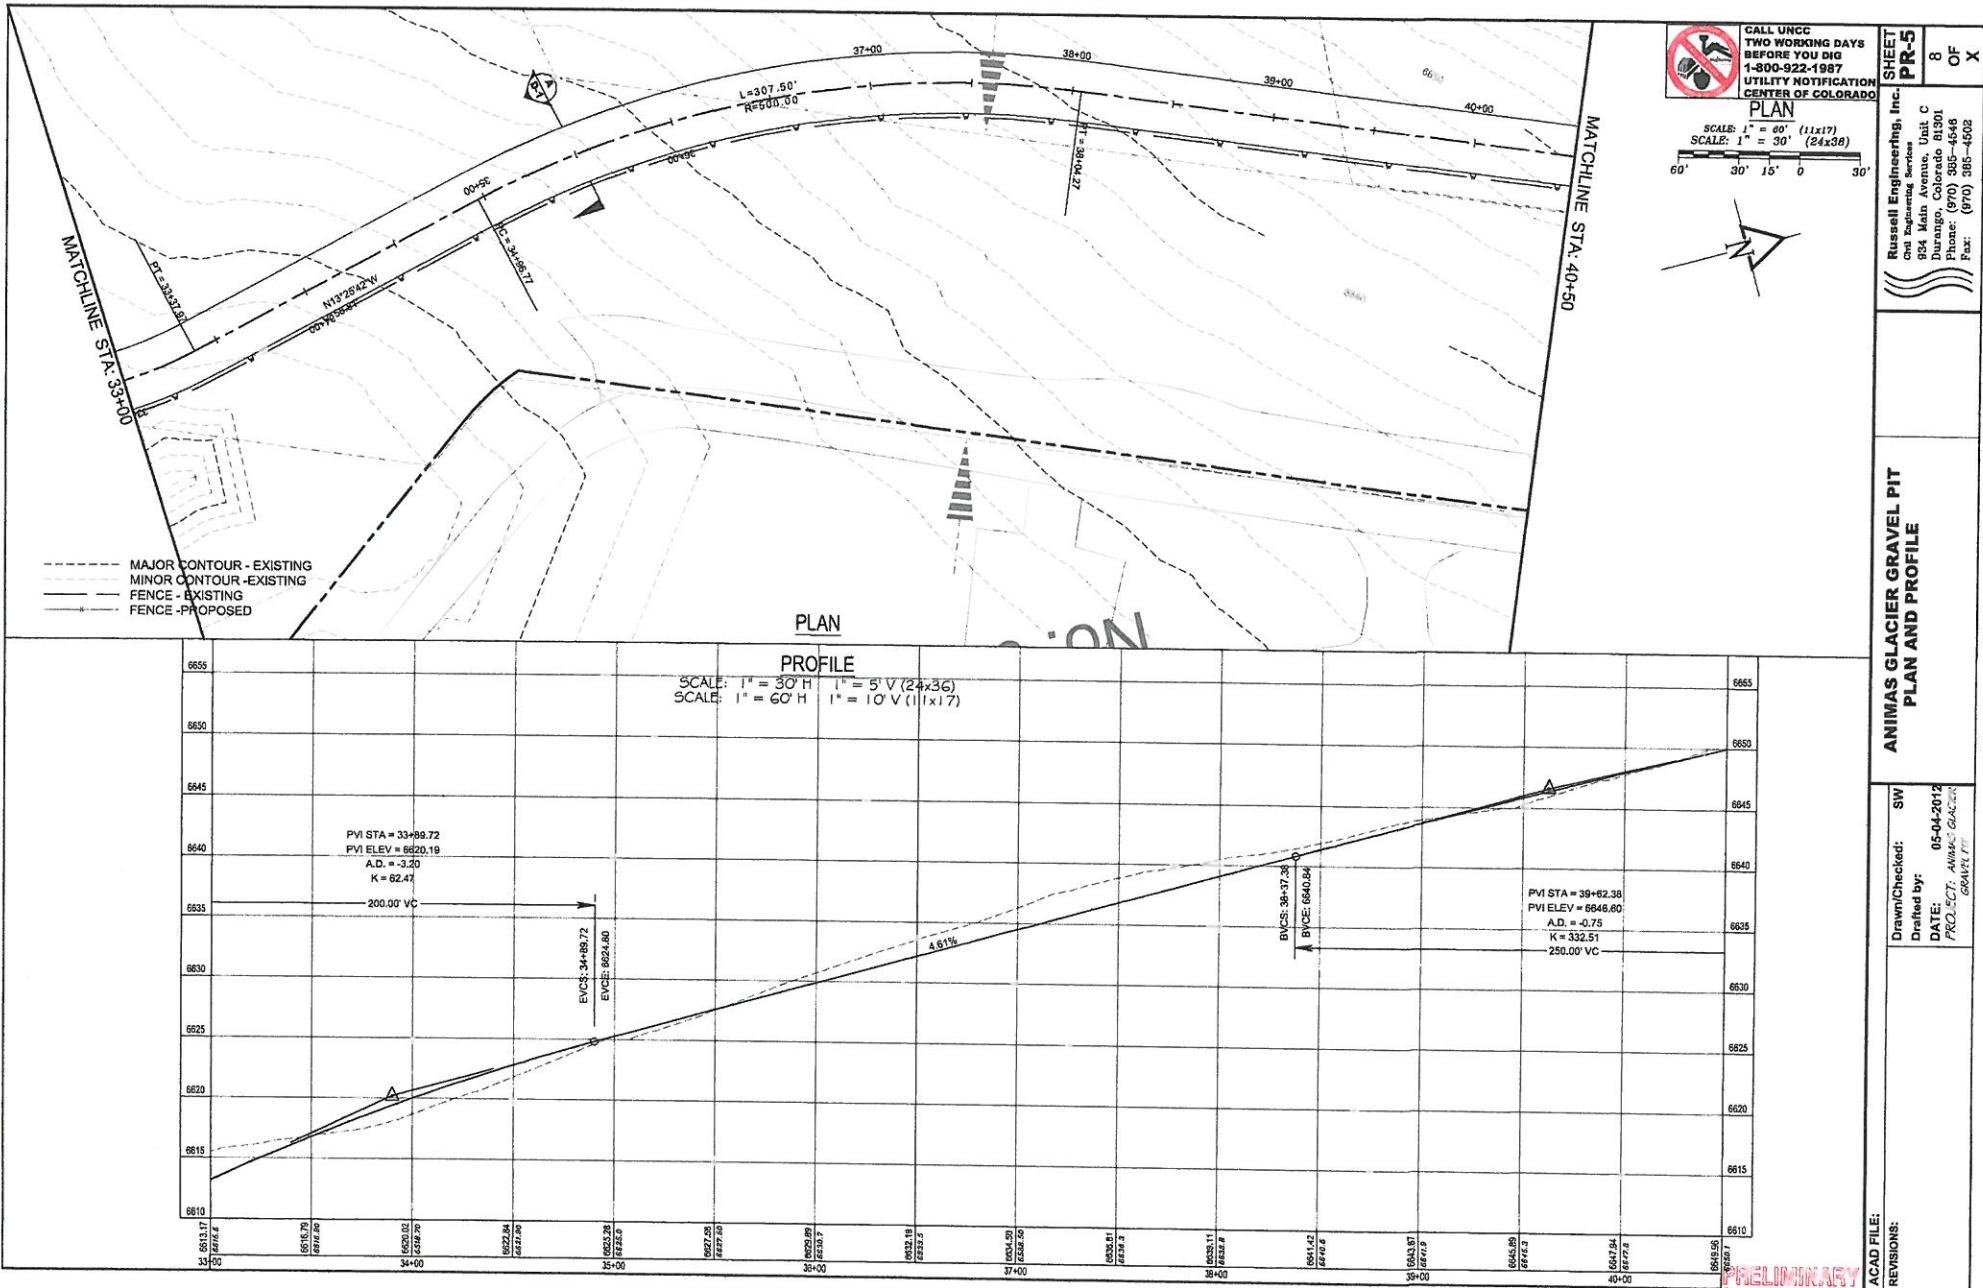
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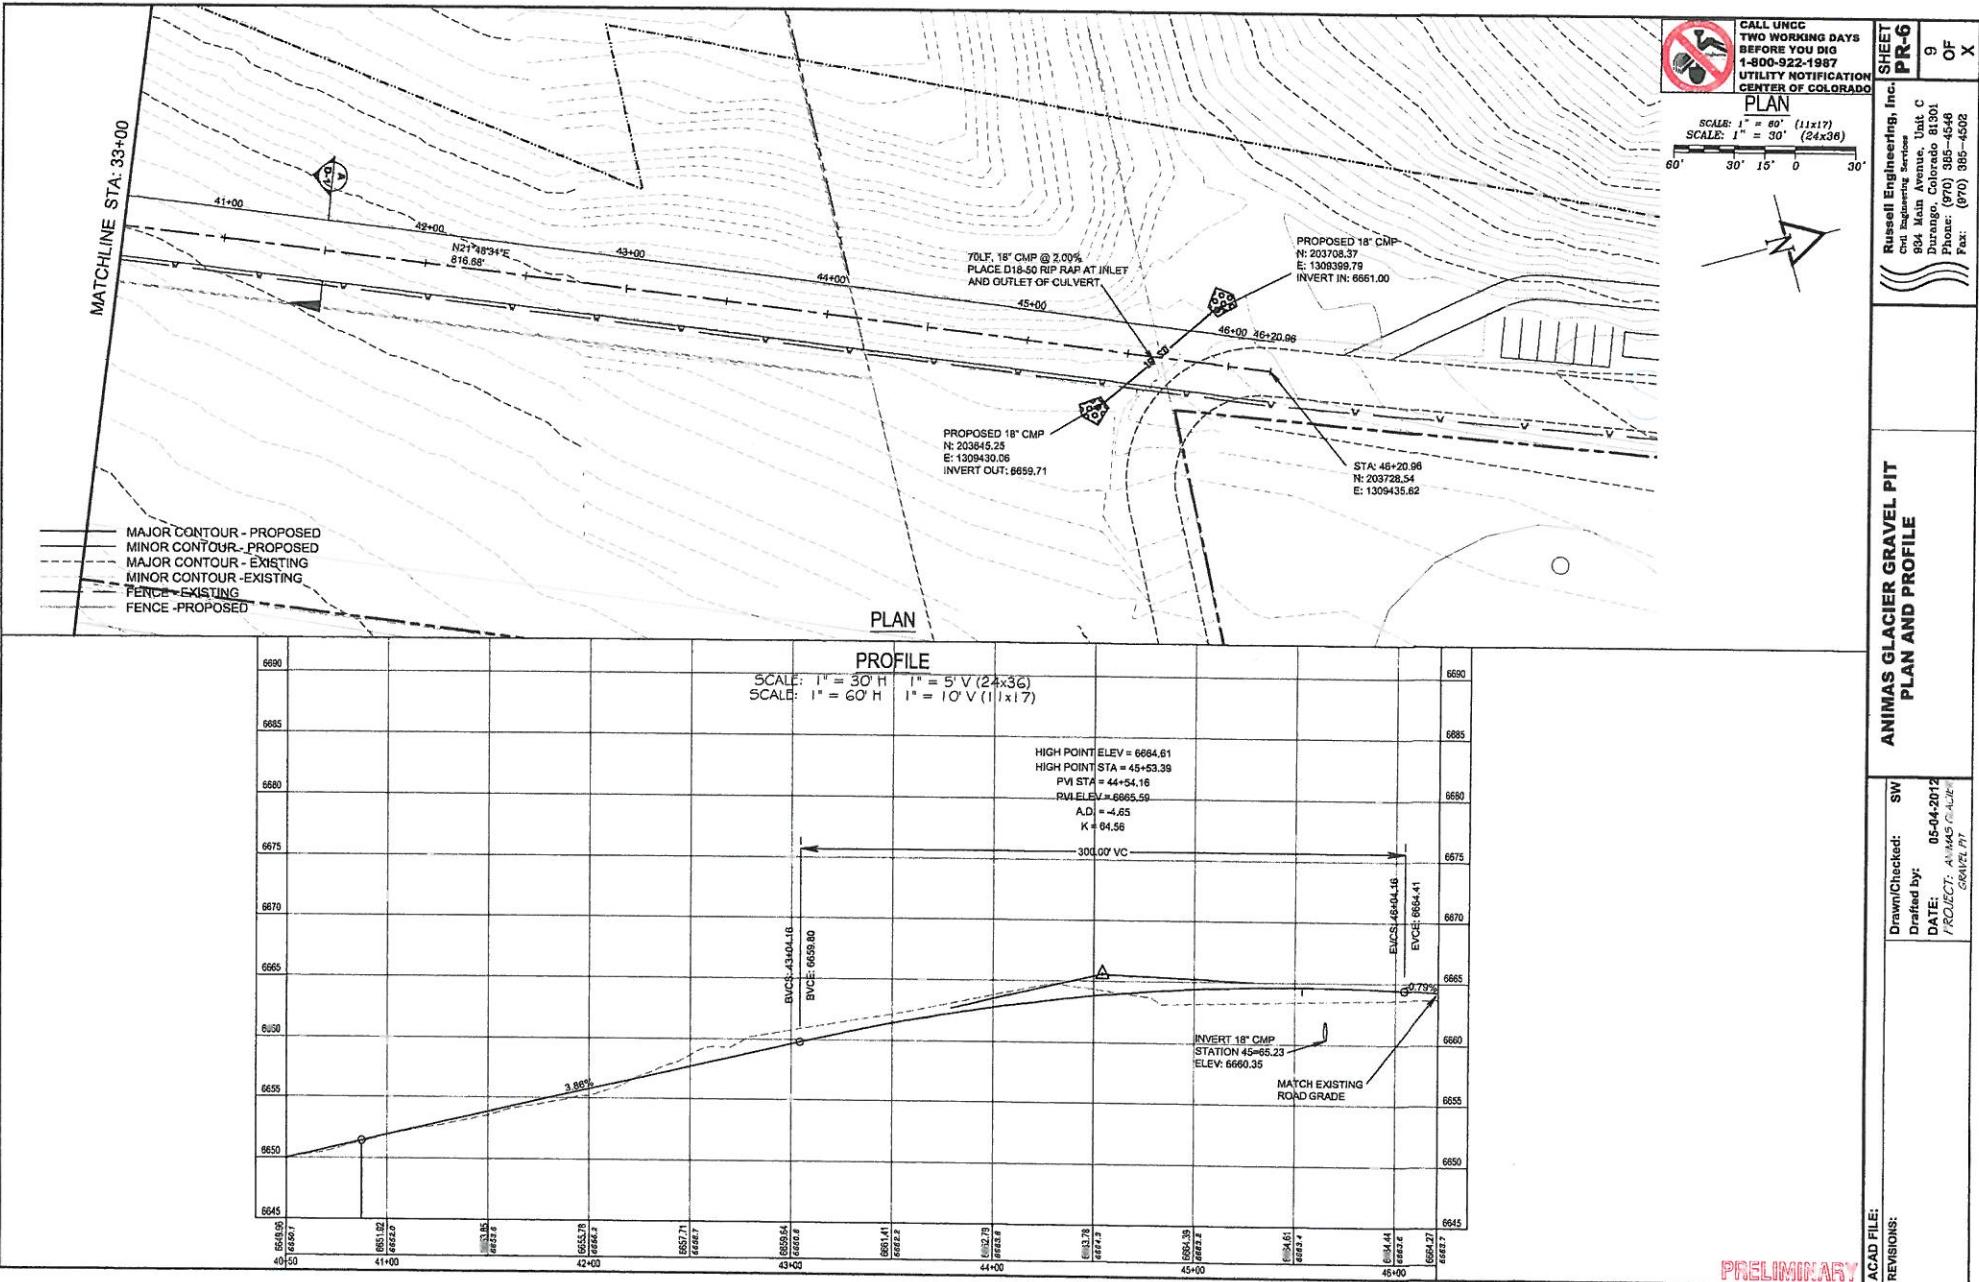
**ANIMAS GLACIER GRAVEL PIT  
PLAN AND PROFILE**


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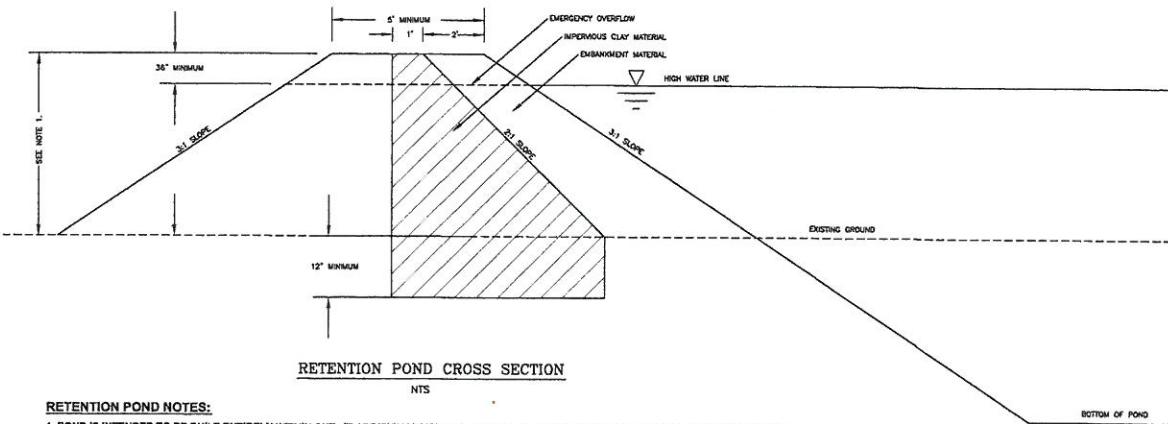





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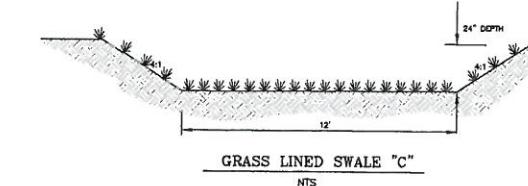
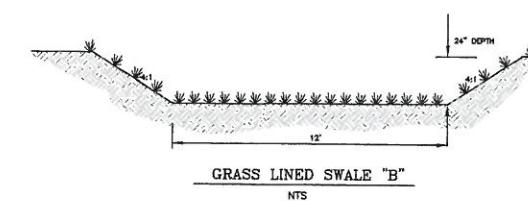
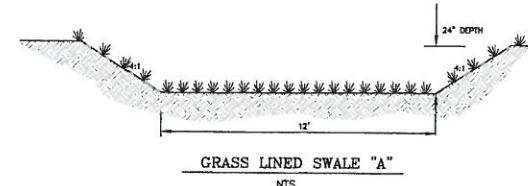
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**RETENTION POND NOTES:**




- POND IS INTENDED TO BE BUILT ENTIRELY WITHIN CUT. IF ADDITIONAL VOLUME IS NEEDED AND EMBANKMENT IS REQUIRED, THE CONTRACTOR SHALL CONSTRUCT THE FILL MATERIAL AS SHOWN, INCLUDING AN EMERGENCY SPILLWAY. IF POND REMAINS ENTIRELY WITHIN CUT, NO CONSIDERATION OF THIS DETAIL IS NECESSARY. HOWEVER, AN OUTLET SWALE SHALL BE CONSTRUCTED TO ALLOW ANY POTENTIAL OVERFLOWS TO EXIT THE POND IN A CONTROLLED CHANNEL.
- CLAY AND EMBANKMENT MATERIAL SHALL BE COMPACTED TO 90% MODIFIED PROCTOR TEST (AASHTO T-180). EMBANKMENT MATERIAL SHALL BE WELL GRADED NATIVE MATERIAL FREE OF ROCKS GREATER THAN 3" IN DIAMETER.
- SLOPES SHALL BE NO MORE THAN 3:1.
- ALL GRADES AND ELEVATIONS SHALL BE DETERMINED BY THE CONTRACTOR AND ENGINEER AT THE TIME OF CONSTRUCTION.
- SEDIMENT SHALL BE REMOVED BY THE OWNER/CONTRACTOR AT REGULAR INTERVALS IN ORDER TO MAINTAIN ADEQUATE STORAGE VOLUMES.
- STORAGE VOLUMES SHALL BE MEASURED BELOW THE EMERGENCY SPILLWAY.

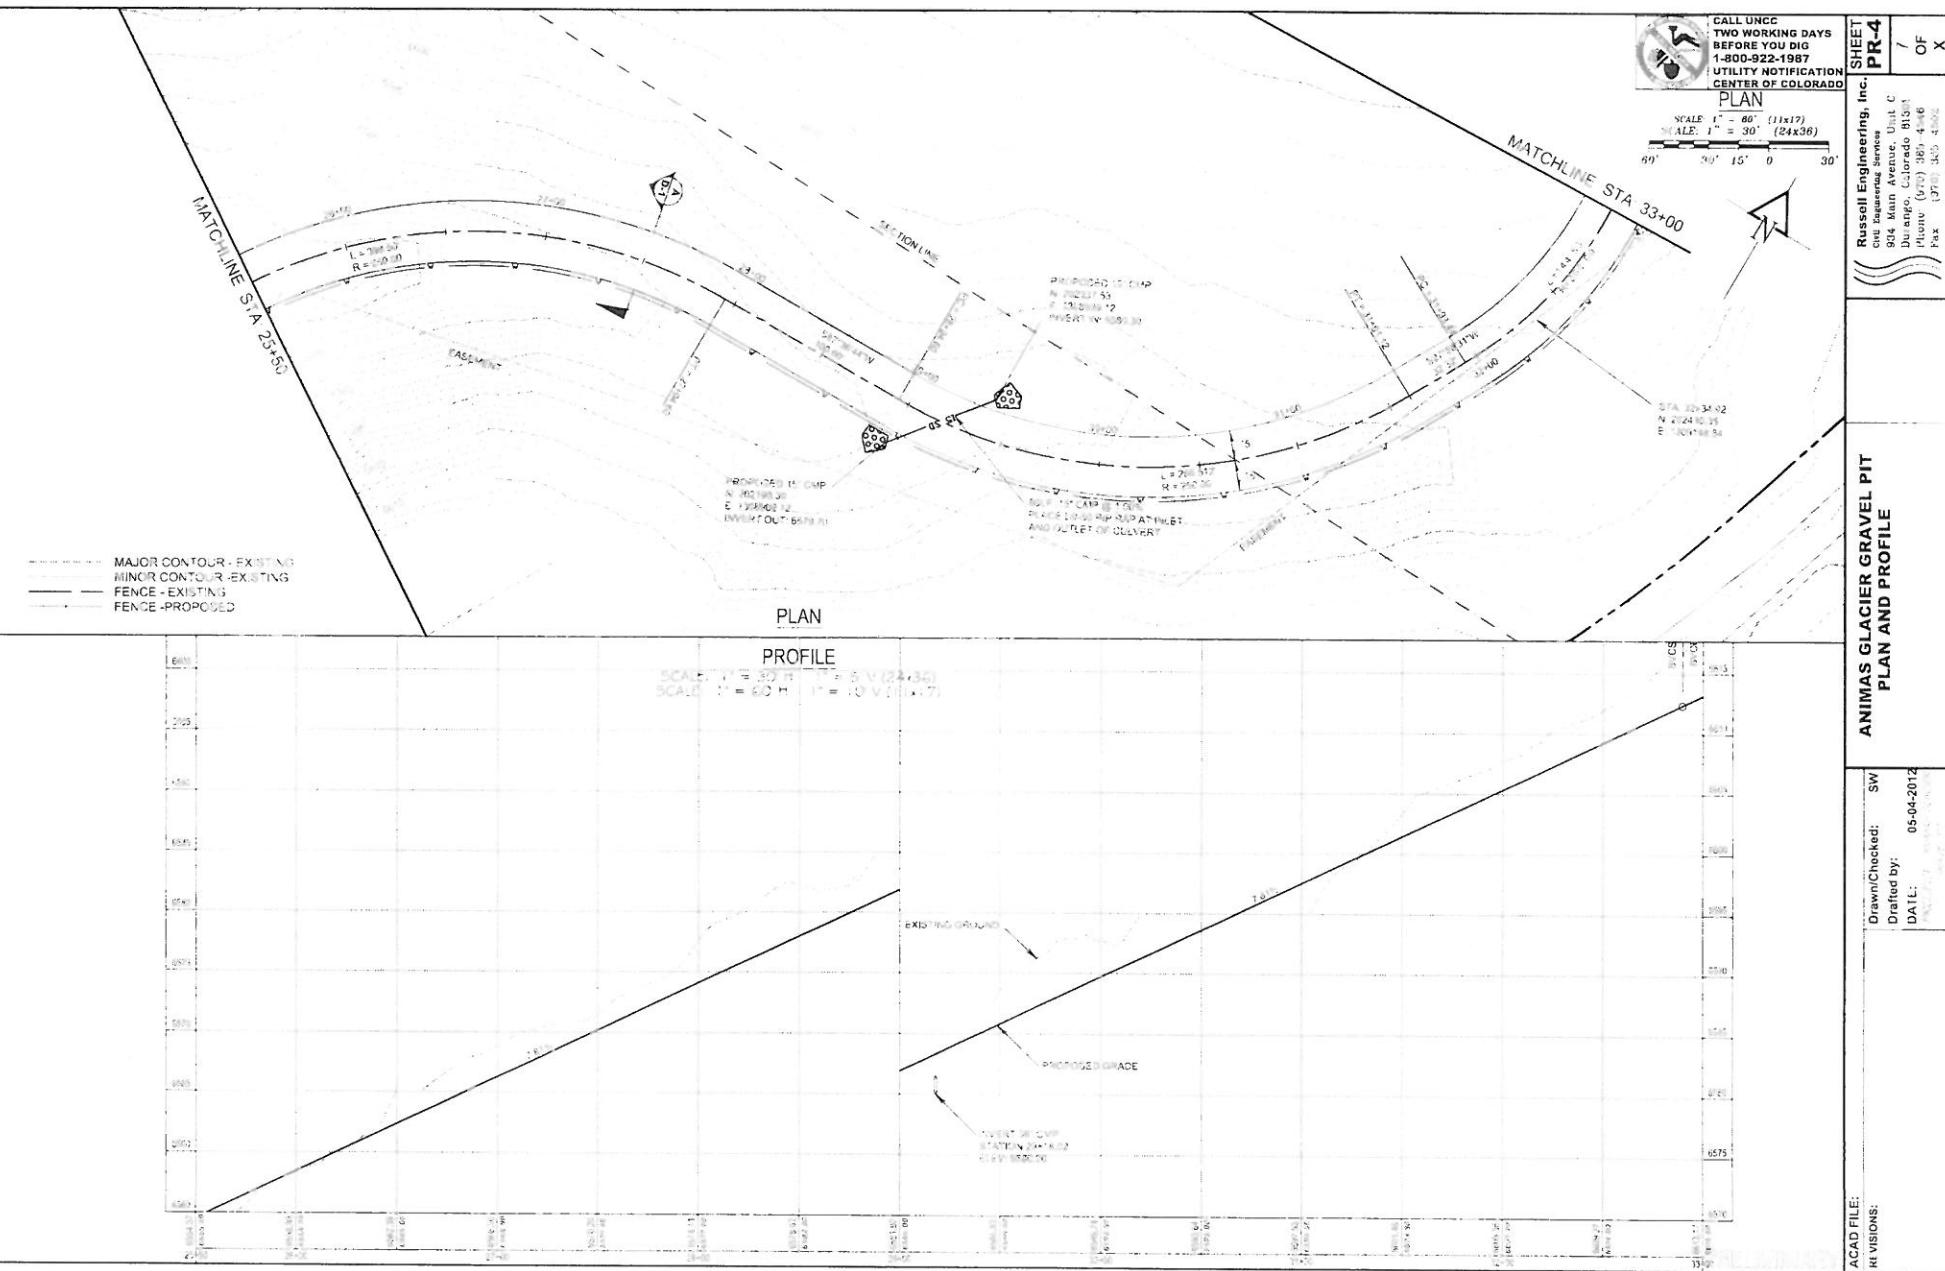

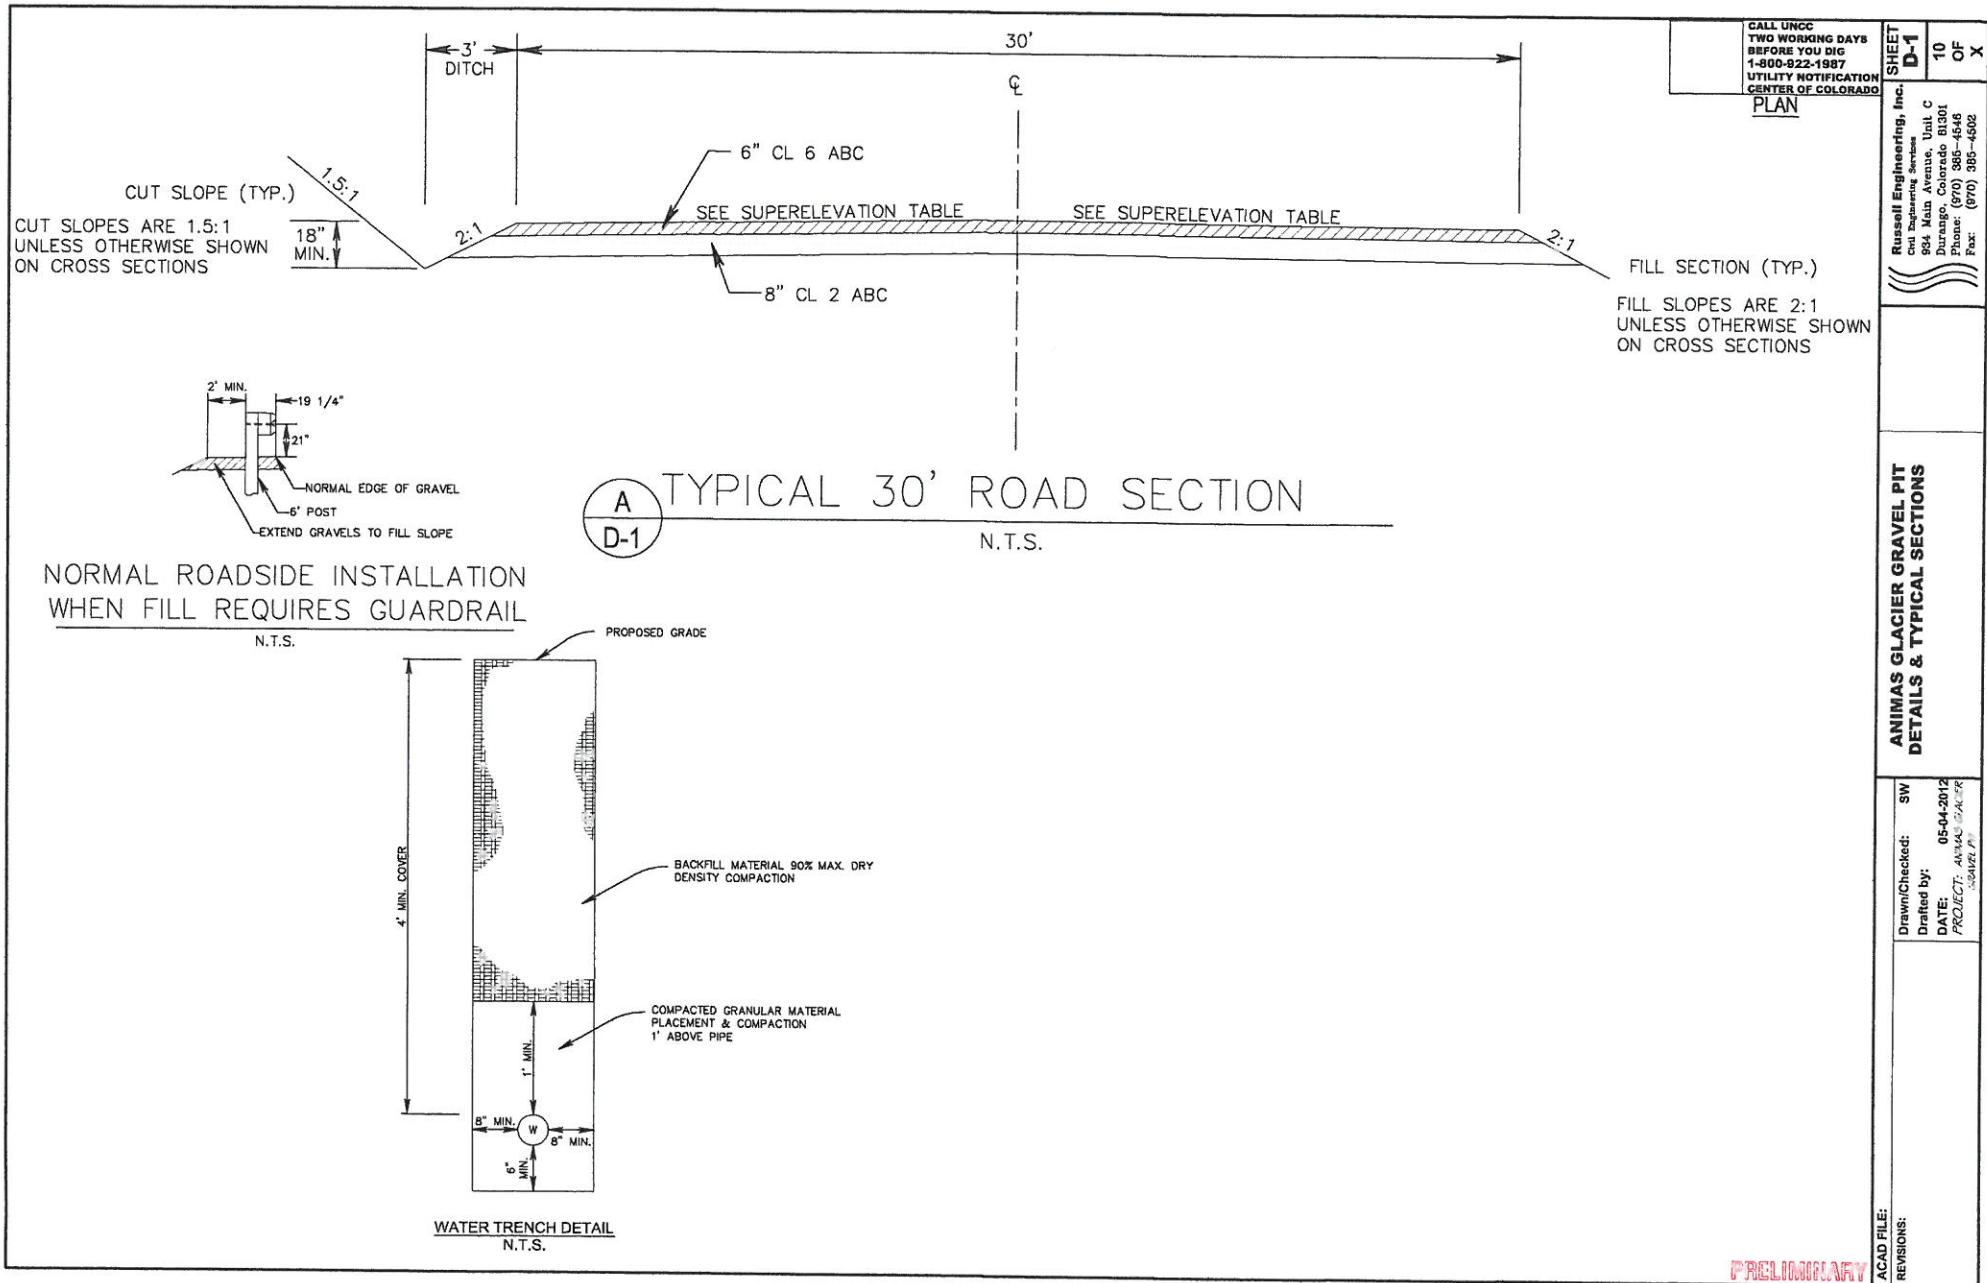**ANIMAS GLACIER GRAVEL PIT  
DETAILS & TYPICAL SECTIONS**

Drawn/Checked:	SW
Drafted by:	05-04-2012
DATE:	PROJECT: ANIMAS GLACIER GRAVEL PIT

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**EMBANKMENT SECTION ALONG EMERGENCY SPILLWAY**

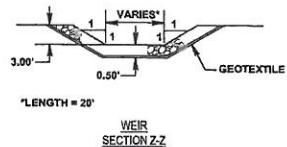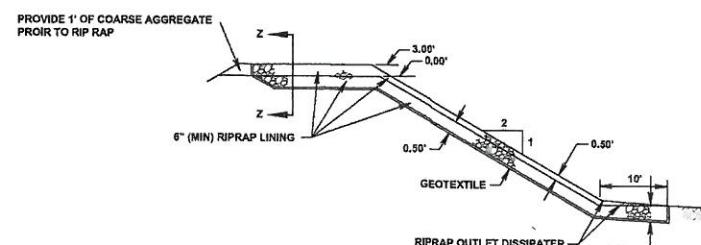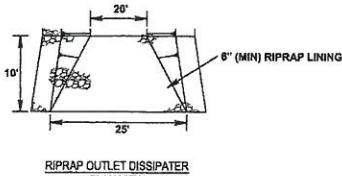**SEDIMENT BASIN EMERGENCY SPILLWAYS  
N.T.S.**

**SWALE NOTES:**

- ALL SWALES SHALL HAVE A MINIMUM SLOPE OF 0.50% AND A MAXIMUM SLOPE OF 1.00%.
- ALL SWALES SHALL HAVE A MAXIMUM SIDE SLOPE OF 4:1.
- CONTRACTOR SHALL CONSULT WITH ENGINEER PRIOR TO ANY DEVIATION FROM THESE REQUIREMENTS

**PRELIMINARY**














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**ANIMAS GLACIER GRAVEL PIT**  
**CROSS SECTIONS**




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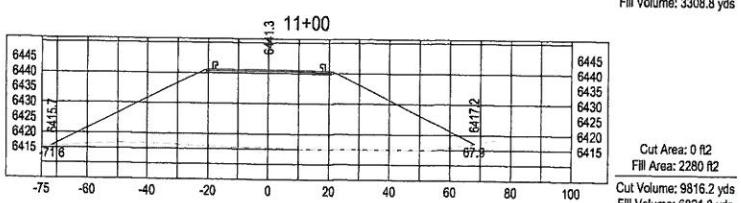
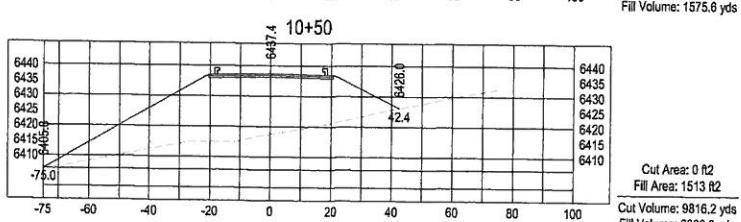
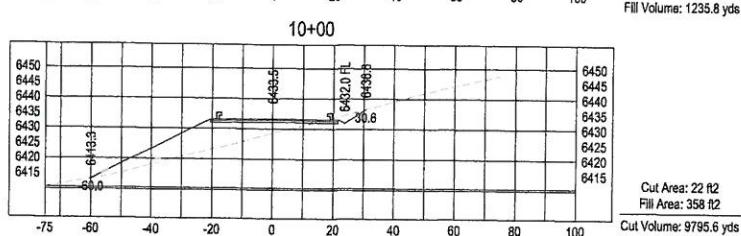
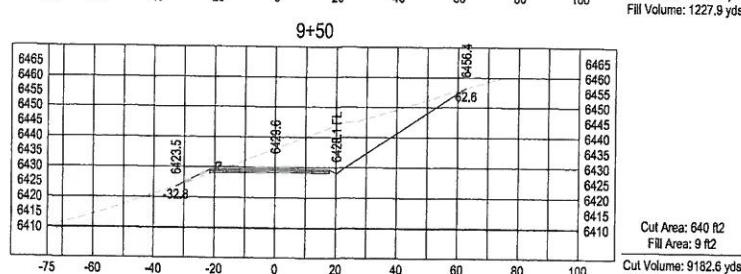
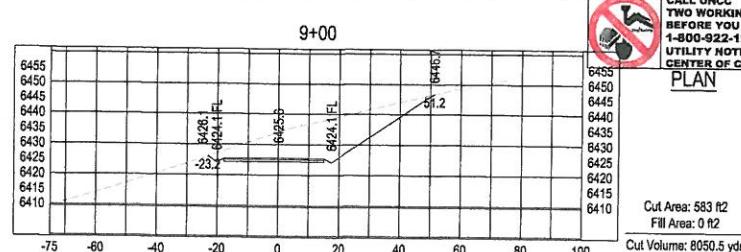
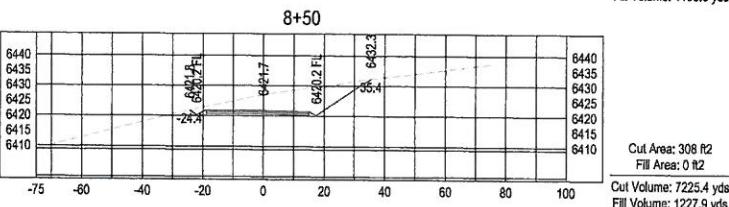
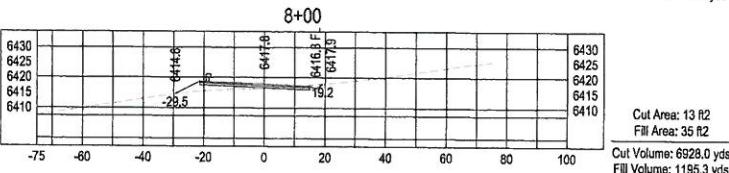
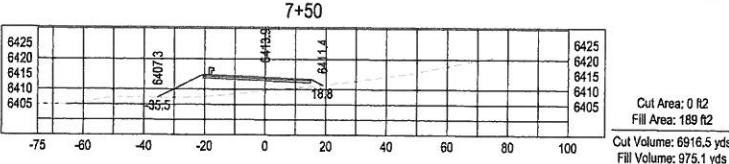
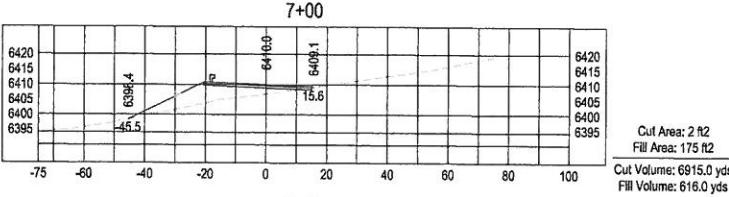
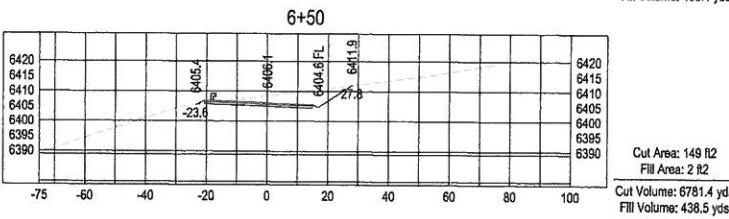
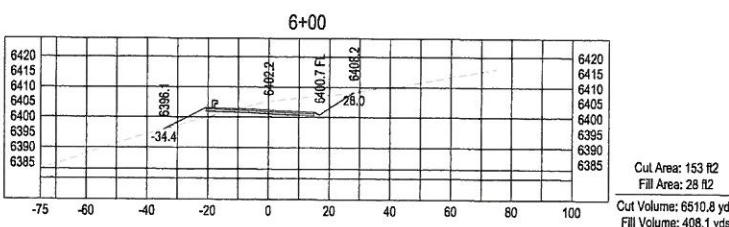
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**ANIMAS GLACIER GRAVEL PIT  
CROSS SECTIONS**












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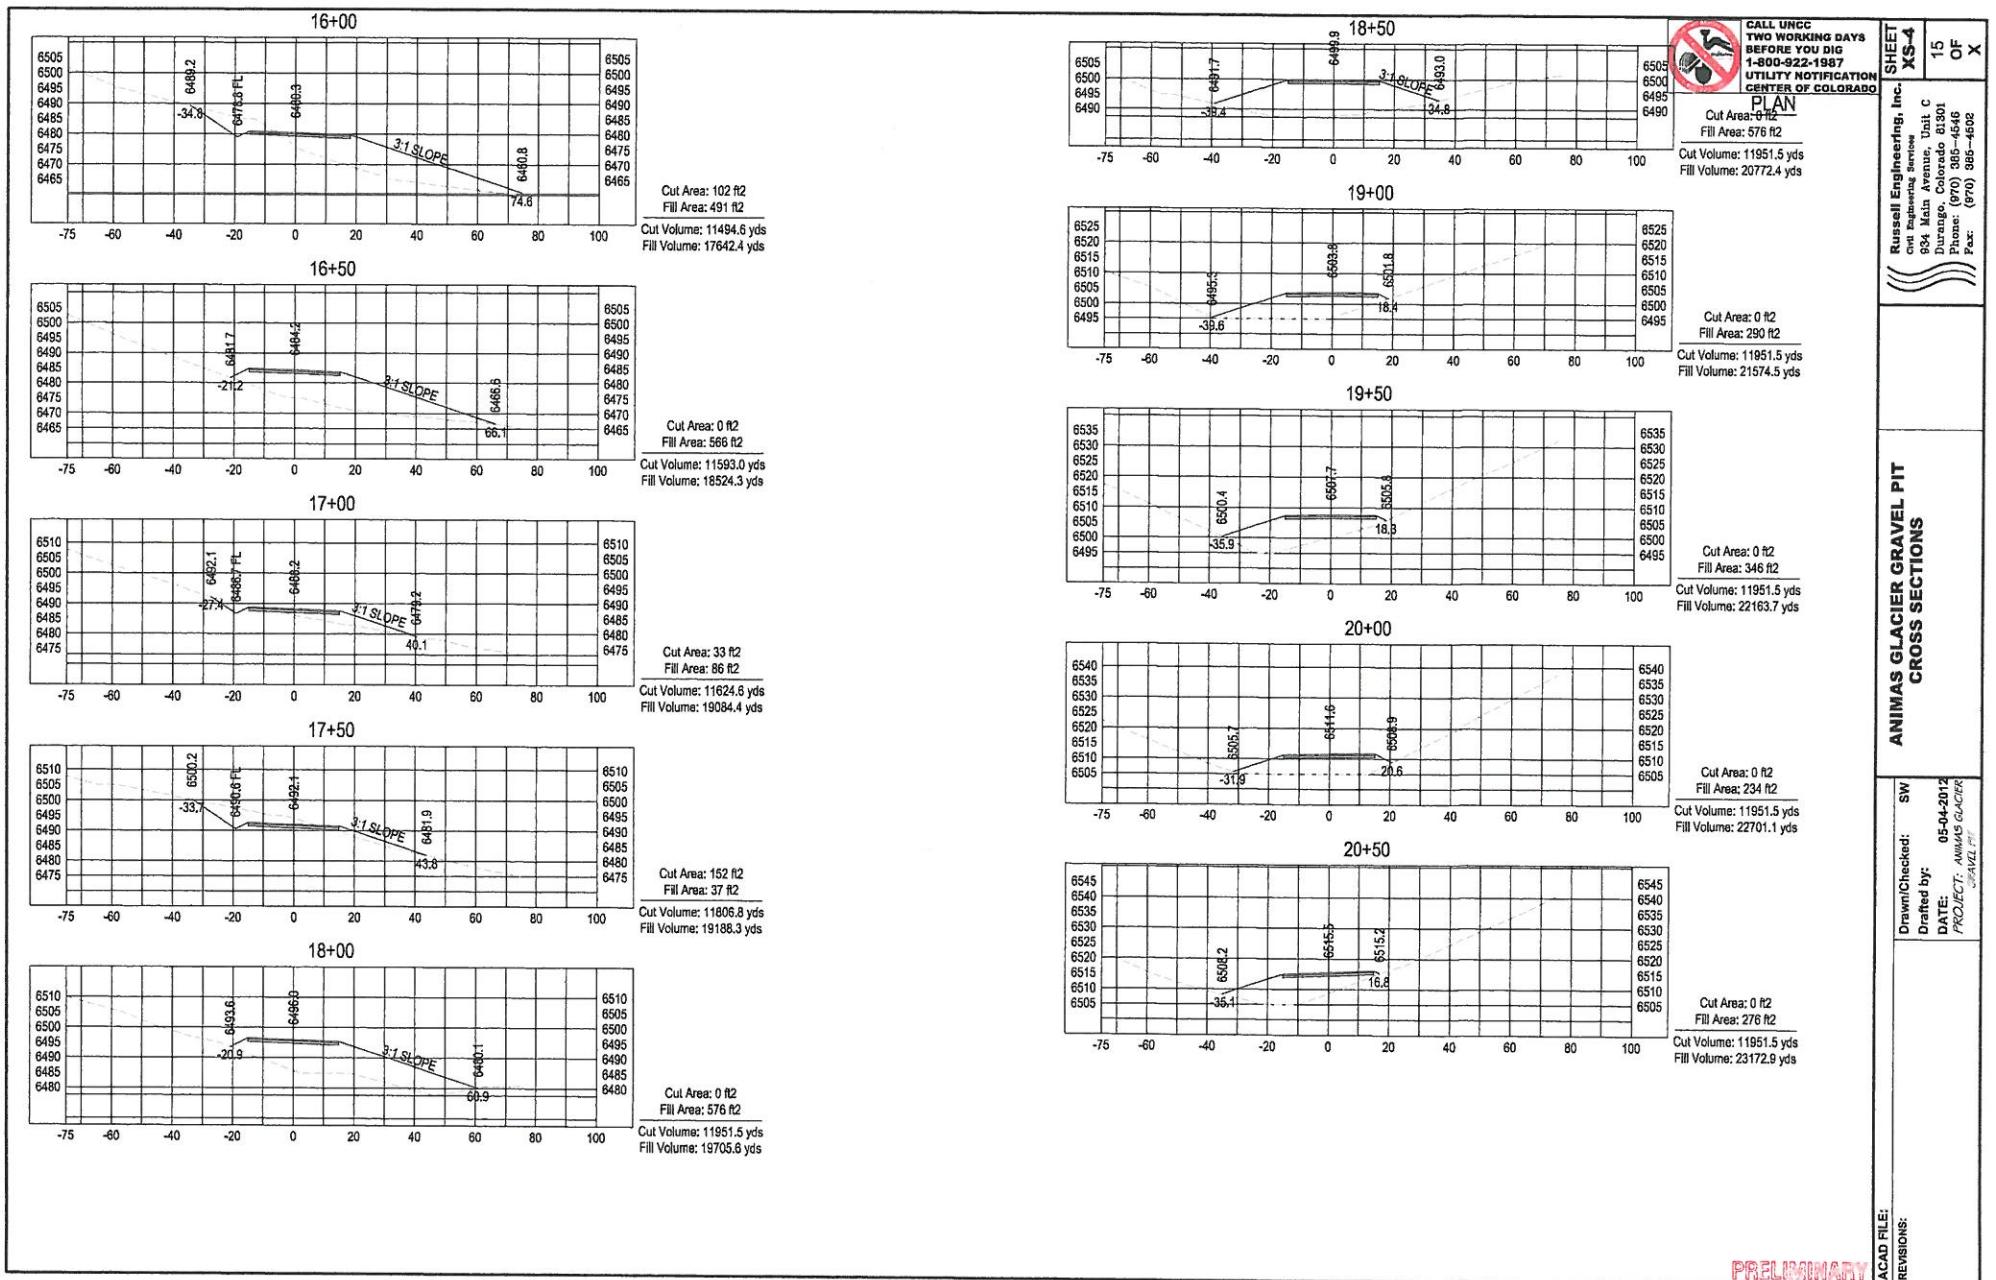
### ANIMAS GLACIER GRAVEL PIT CROSS SECTIONS
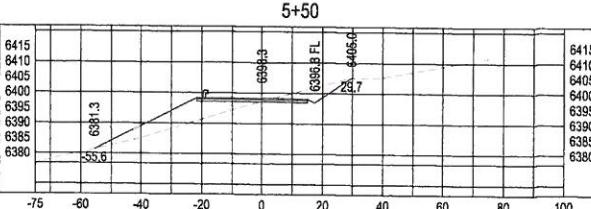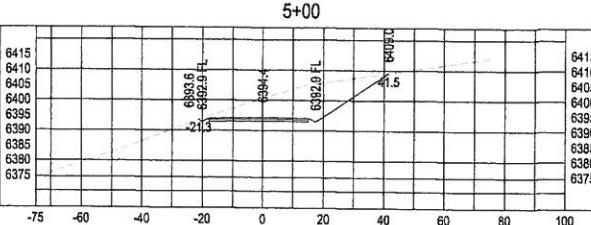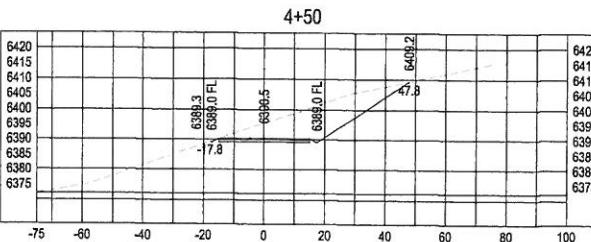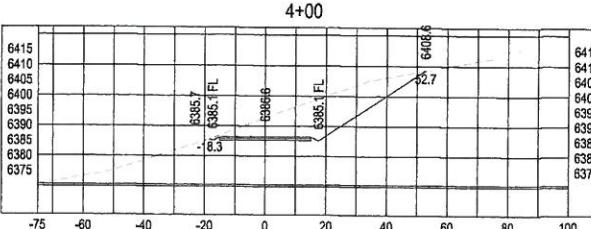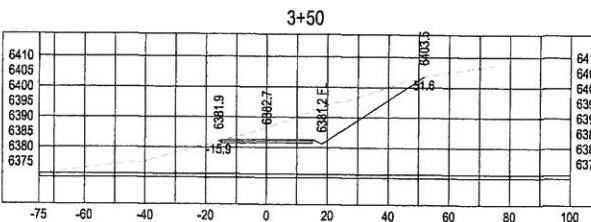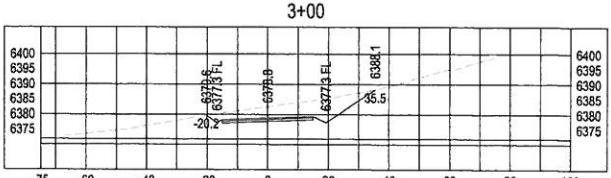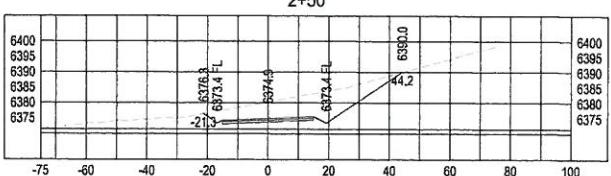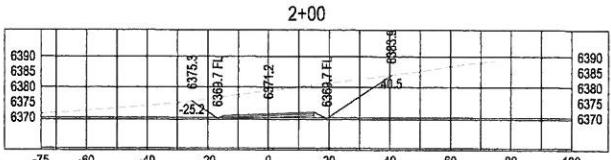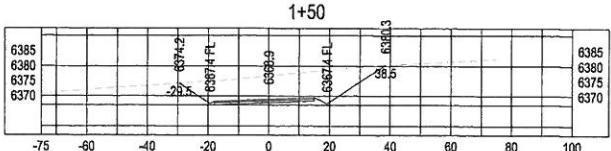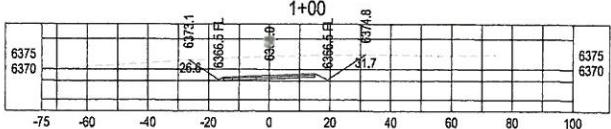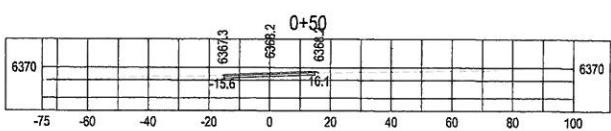
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PRELIMINARY

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Animas Gravel Pit
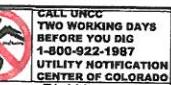
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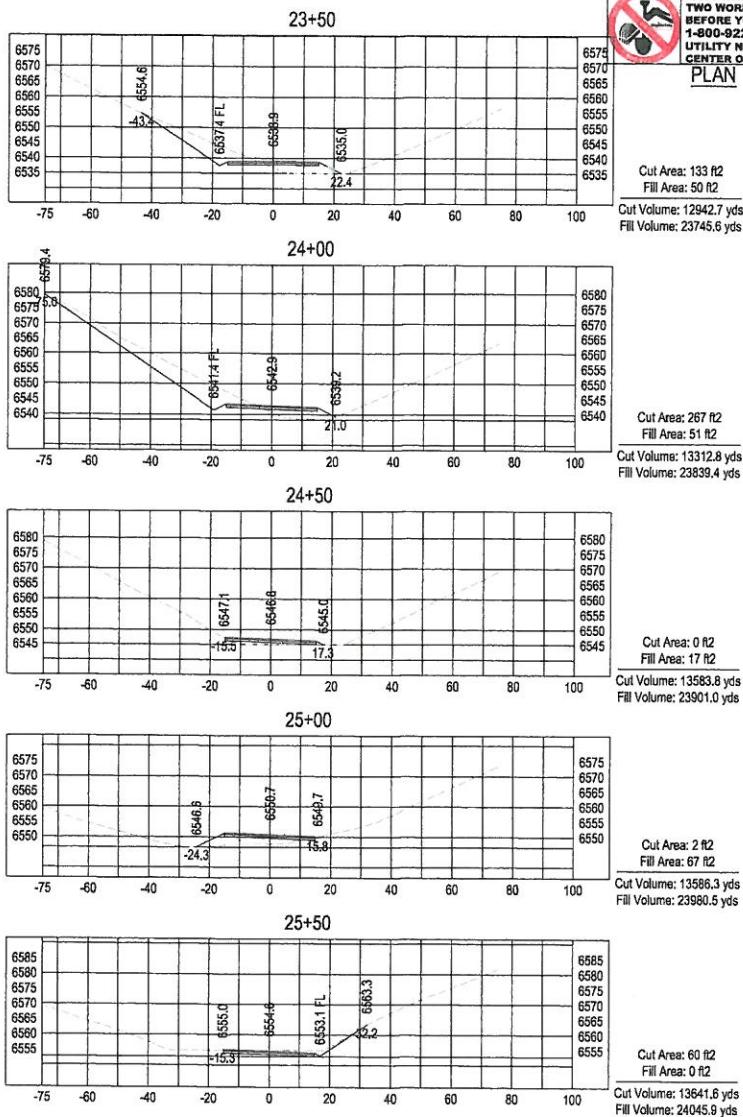
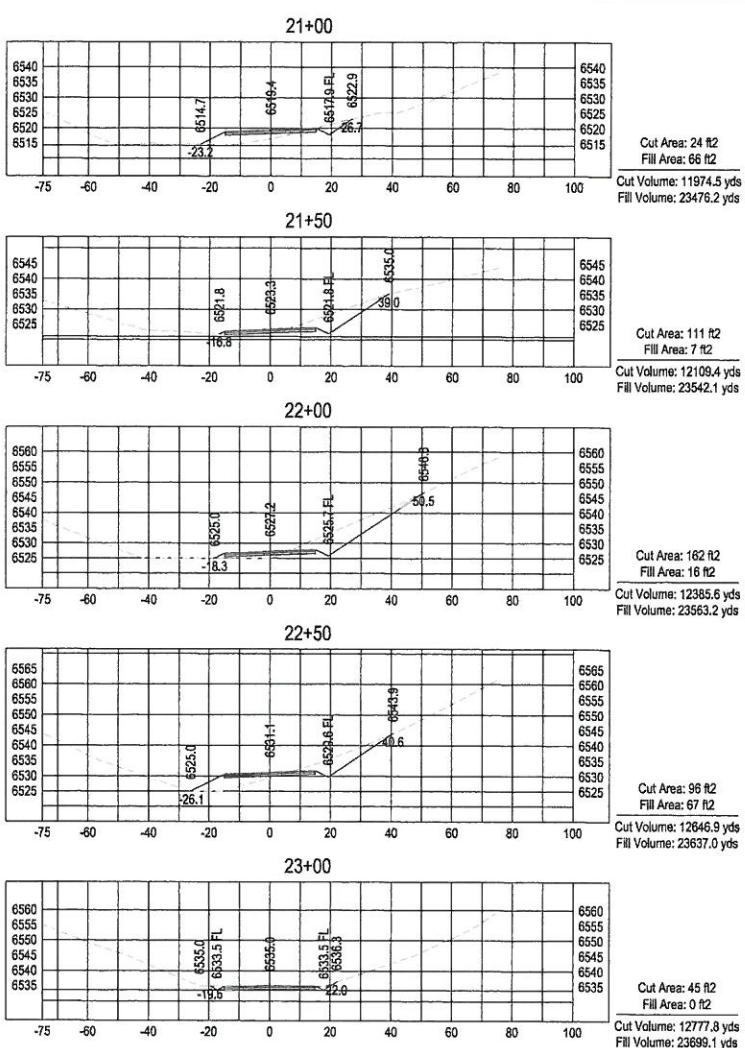


SHEET  
XSS-5

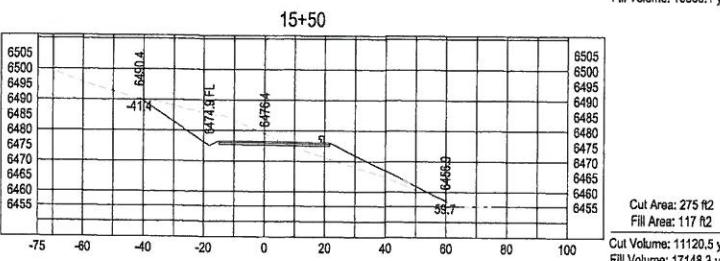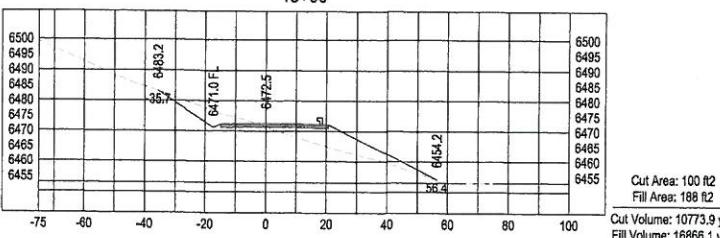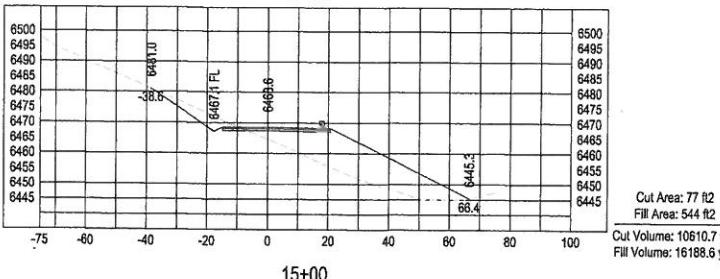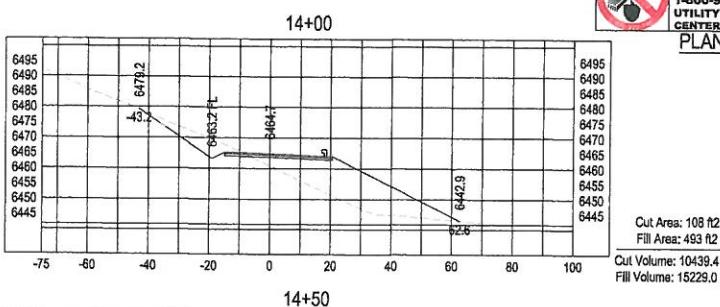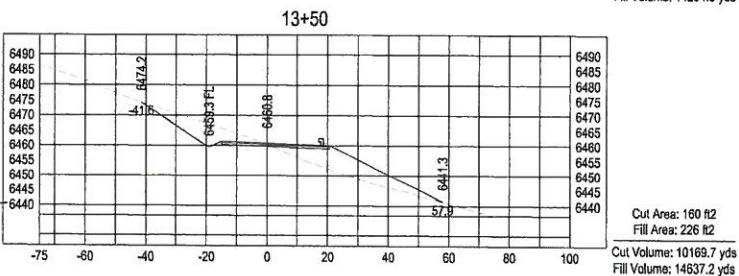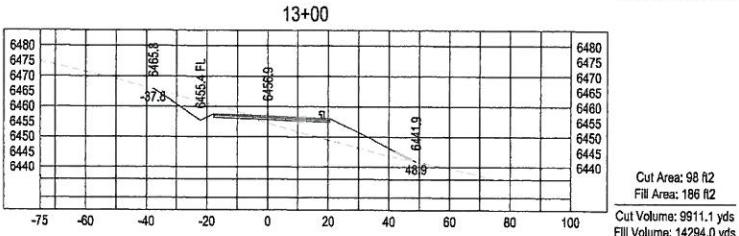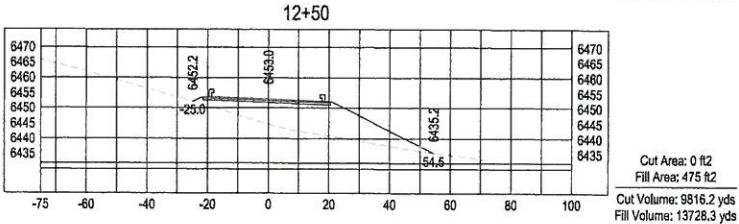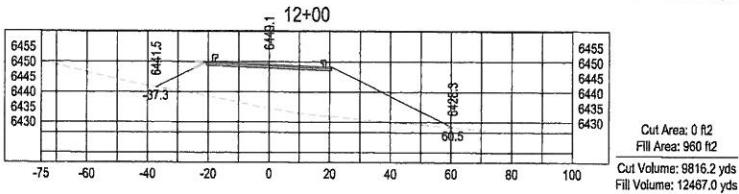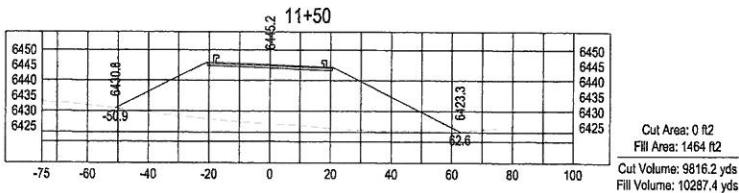Russell Engineering, Inc.  
Civil Engineering Services  
854 Main Avenue, Telluride, CO 81430  
Phone: (970) 728-4566  
(877) 566-4562  
Fax:


**ANIMAS GLACIER GRAVEL PIT**  
**CROSS SECTIONS**

ACAD FILE:  
REVISIONS:



Drawn/Checked:	SW
Drafted by:	05-04-2012
DATE:	PROJECT: Animas Glacier Gravel Pit

PRELIMINARY

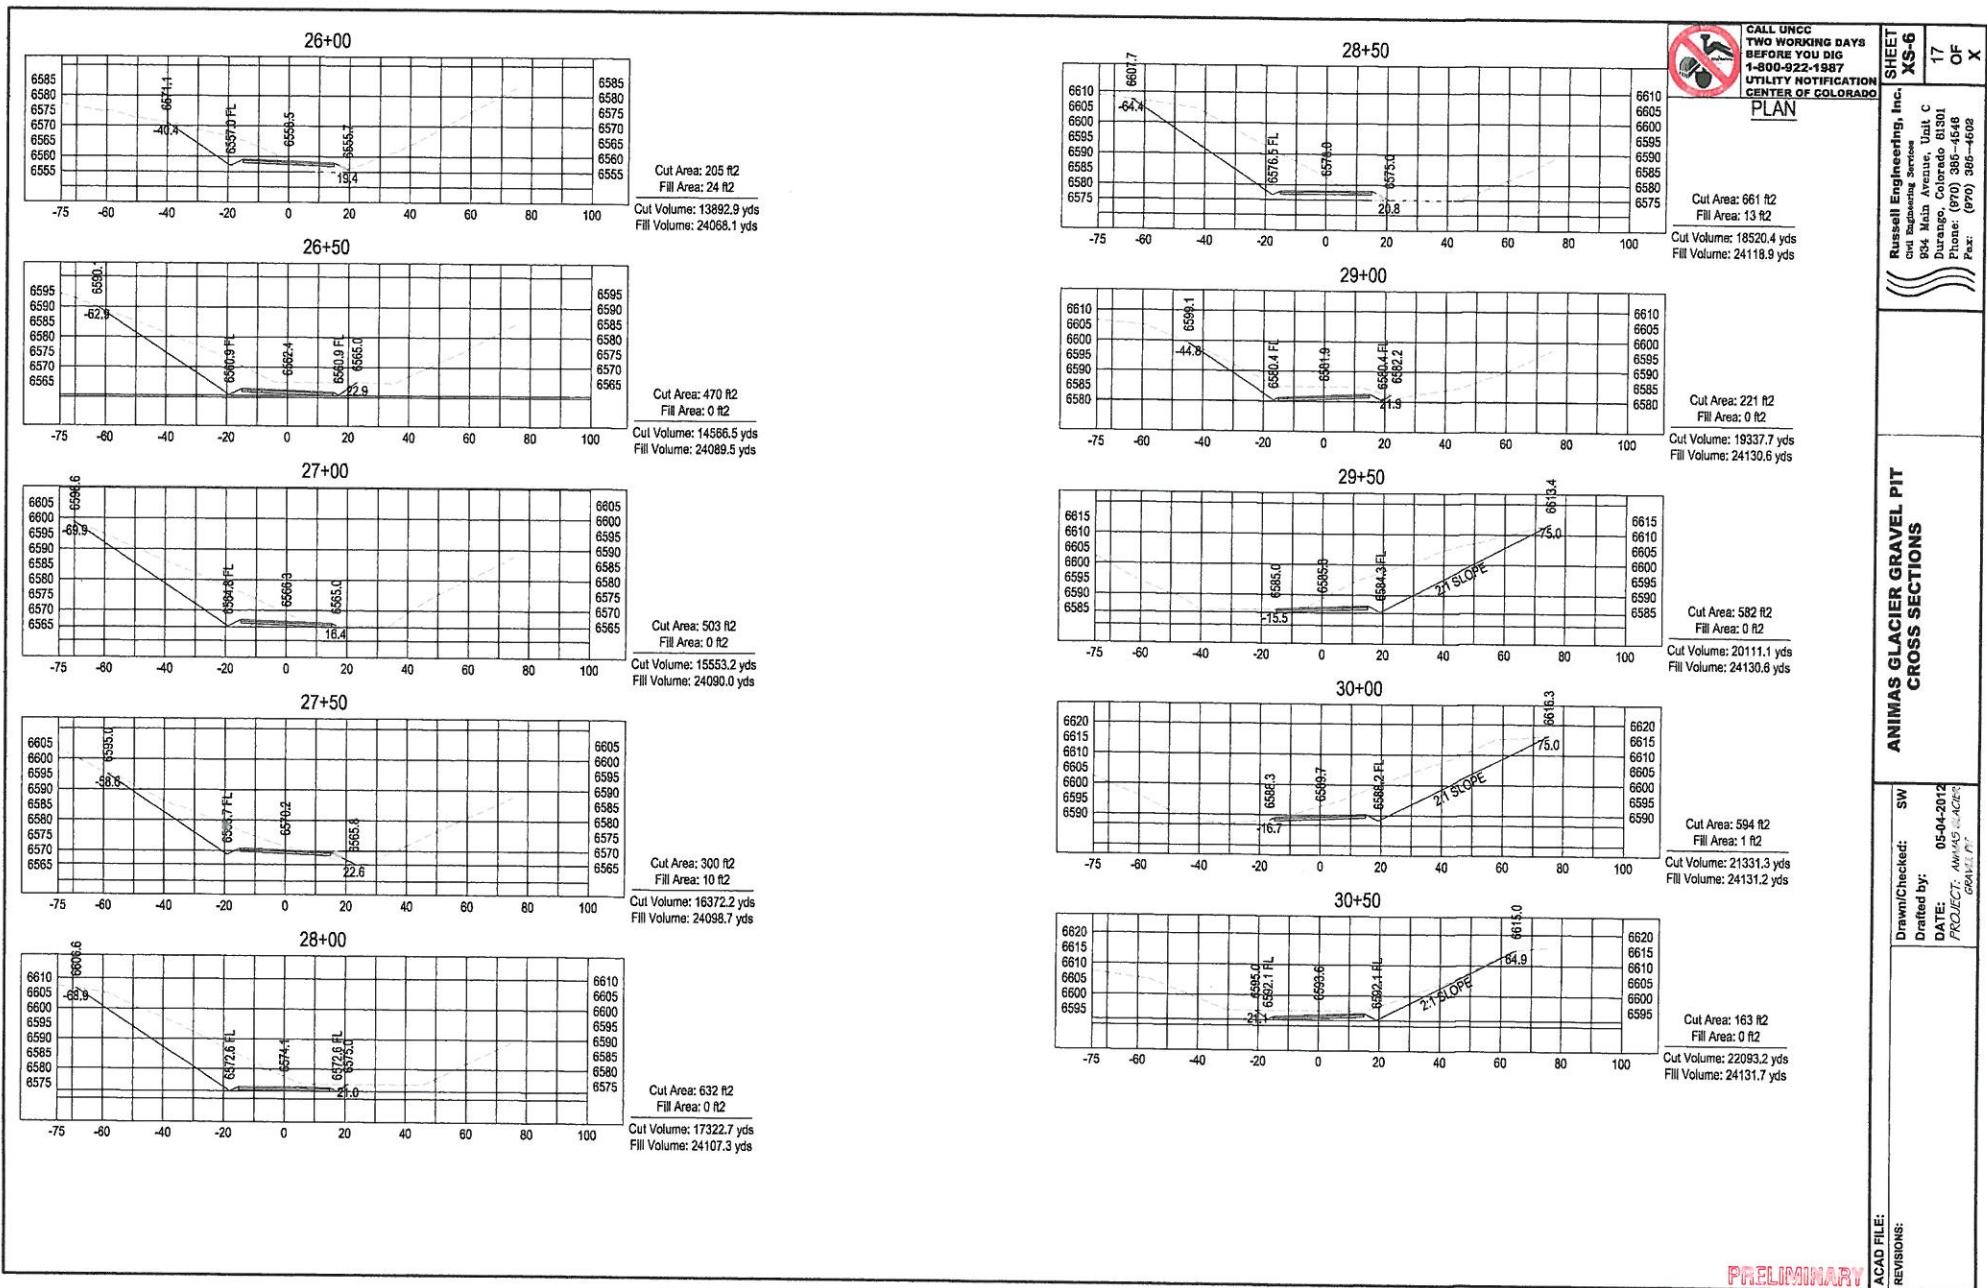

Preliminary



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UTILITY NOTIFICATION  
CENTER OF COLORADO

PLAN


SHEET  
X-8-7  
18  
OF  
X

**ANIMAS GLACIER GRAVEL PIT  
CROSS SECTIONS**

ACAD FILE:  
REVISIONS:


Drawn/Checked: SW  
Drafted by: 05-04-2012  
DATE: PROJECT: animas glacier  
Phone: (970) 386-4502  
Fax: (970) 386-4502

31+00

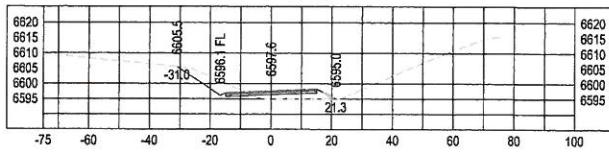


Cut Area: 68 ft<sup>2</sup>  
Fill Area: 41 ft<sup>2</sup>  
Cut Volume: 22304.9 yds  
Fill Volume: 24170.5 yds

31+50

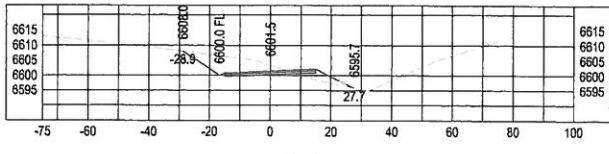


Cut Area: 140 ft<sup>2</sup>  
Fill Area: 30 ft<sup>2</sup>  
Cut Volume: 22486.1 yds  
Fill Volume: 24239.7 yds

32+00

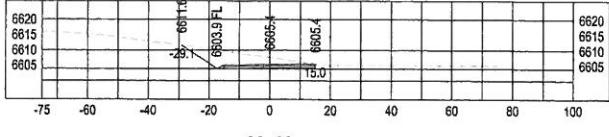


Cut Area: 154 ft<sup>2</sup>  
Fill Area: 0 ft<sup>2</sup>  
Cut Volume: 22757.9 yds  
Fill Volume: 24267.3 yds

32+00

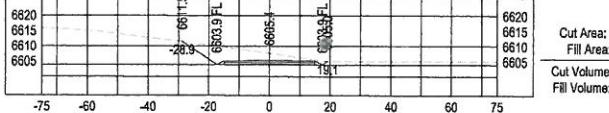


Cut Area: 158 ft<sup>2</sup>  
Fill Area: 0 ft<sup>2</sup>  
Cut Volume: 0.0 yds  
Fill Volume: 0.0 yds

32+50

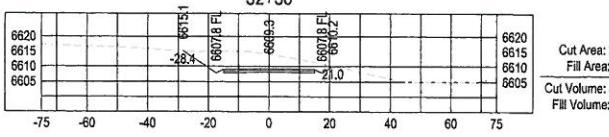


Cut Area: 240 ft<sup>2</sup>  
Fill Area: 0 ft<sup>2</sup>  
Cut Volume: 357.4 yds  
Fill Volume: 0.0 yds

33+00

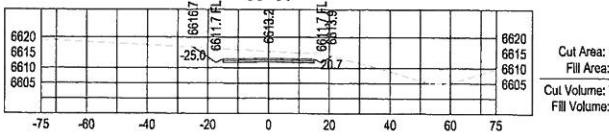


Cut Area: 149 ft<sup>2</sup>  
Fill Area: 0 ft<sup>2</sup>  
Cut Volume: 710.7 yds  
Fill Volume: 0.0 yds

33+50

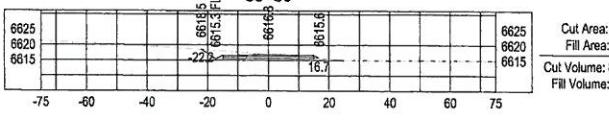


Cut Area: 54 ft<sup>2</sup>  
Fill Area: 1 ft<sup>2</sup>  
Cut Volume: 893.6 yds  
Fill Volume: 0.6 yds

34+00

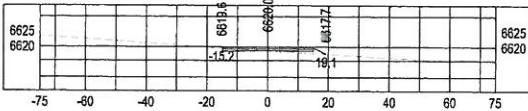


Cut Area: 6 ft<sup>2</sup>  
Fill Area: 10 ft<sup>2</sup>  
Cut Volume: 949.2 yds  
Fill Volume: 10.3 yds

34+50

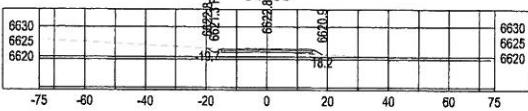


Cut Area: 14 ft<sup>2</sup>  
Fill Area: 4 ft<sup>2</sup>  
Cut Volume: 986.3 yds  
Fill Volume: 22.7 yds

35+00

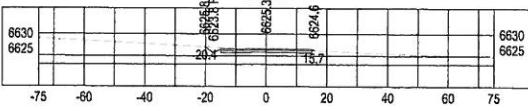


Cut Area: 37 ft<sup>2</sup>  
Fill Area: 0 ft<sup>2</sup>  
Cut Volume: 1016.1 yds  
Fill Volume: 26.1 yds

35+50

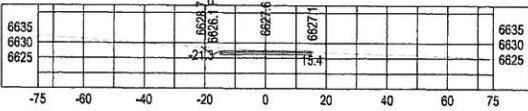


Cut Area: 48 ft<sup>2</sup>  
Fill Area: 0 ft<sup>2</sup>  
Cut Volume: 1095.0 yds  
Fill Volume: 26.2 yds

36+00

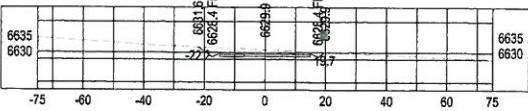


Cut Area: 82 ft<sup>2</sup>  
Fill Area: 0 ft<sup>2</sup>  
Cut Volume: 1217.5 yds  
Fill Volume: 26.3 yds

36+50

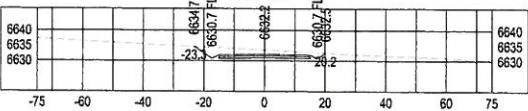


Cut Area: 105 ft<sup>2</sup>  
Fill Area: 0 ft<sup>2</sup>  
Cut Volume: 1391.4 yds  
Fill Volume: 26.3 yds

37+00

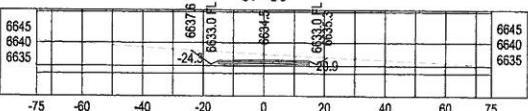

Cut Area: 126 ft<sup>2</sup>  
Fill Area: 0 ft<sup>2</sup>  
Cut Volume: 1606.8 yds  
Fill Volume: 26.3 yds

37+50

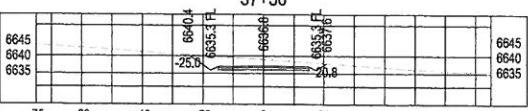

Cut Area: 138 ft<sup>2</sup>  
Fill Area: 0 ft<sup>2</sup>  
Cut Volume: 1852.9 yds  
Fill Volume: 26.3 yds

FREQUENTARY



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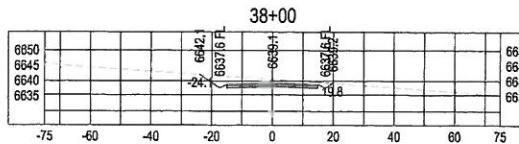
PLAN

SHEET  
X5-8  
19  
OF  
X


**ANIMAS GLACIER GRAVEL PIT**

ACAD FILE:  
REVISIONS:


Russell Engineering, Inc.  
Civil Engineering Services  
934 Main Avenue, Unit C  
Durango, Colorado 81301  
Phone: (970) 386-4546  
(970) 386-4502  
Fax:




Cut Area: 108 ft<sup>2</sup>  
Fill Area: 0 ft<sup>2</sup>  
Cut Volume: 2081.8 yds  
Fill Volume: 26.3 yds

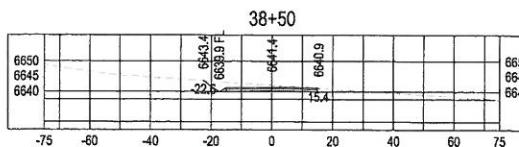


Cut Area: 69 ft<sup>2</sup>  
Fill Area: 0 ft<sup>2</sup>  
Cut Volume: 2245.6 yds  
Fill Volume: 26.3 yds

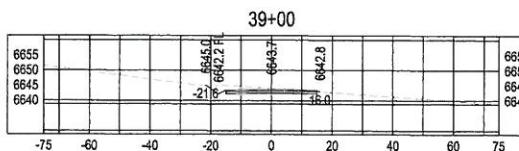


Cut Area: 59 ft<sup>2</sup>  
Fill Area: 0 ft<sup>2</sup>  
Cut Volume: 2364.6 yds  
Fill Volume: 26.5 yds

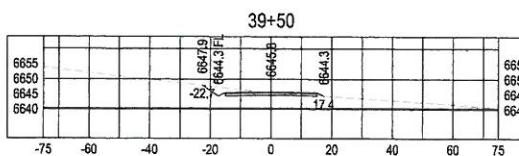


Cut Area: 42 ft<sup>2</sup>  
Fill Area: 1 ft<sup>2</sup>  
Cut Volume: 2458.5 yds  
Fill Volume: 27.9 yds

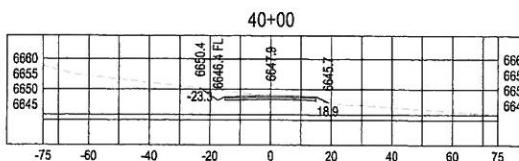


Cut Area: 51 ft<sup>2</sup>  
Fill Area: 4 ft<sup>2</sup>  
Cut Volume: 2545.1 yds  
Fill Volume: 32.5 yds

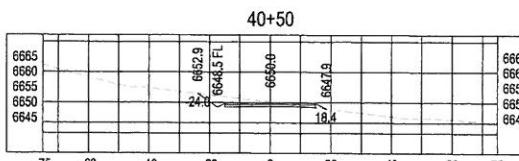


Cut Area: 62 ft<sup>2</sup>  
Fill Area: 2 ft<sup>2</sup>  
Cut Volume: 2649.9 yds  
Fill Volume: 38.2 yds

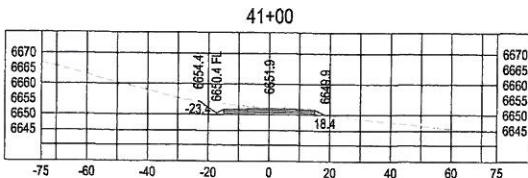


Cut Area: 56 ft<sup>2</sup>  
Fill Area: 2 ft<sup>2</sup>  
Cut Volume: 2758.9 yds  
Fill Volume: 42.6 yds

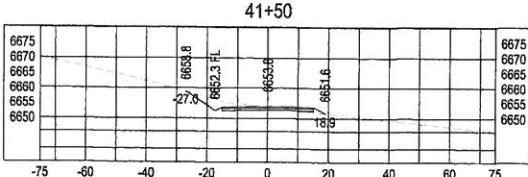


Cut Area: 57 ft<sup>2</sup>  
Fill Area: 4 ft<sup>2</sup>  
Cut Volume: 2863.5 yds  
Fill Volume: 48.3 yds

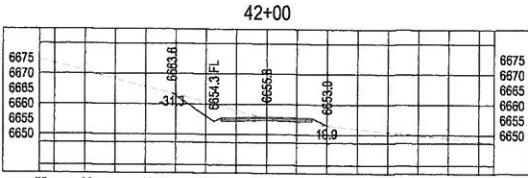


Cut Area: 95 ft<sup>2</sup>  
Fill Area: 9 ft<sup>2</sup>  
Cut Volume: 3003.9 yds  
Fill Volume: 59.8 yds

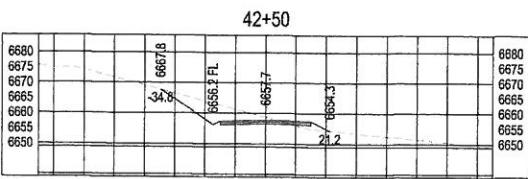

Cut Area: 149 ft<sup>2</sup>  
Fill Area: 12 ft<sup>2</sup>  
Cut Volume: 3229.0 yds  
Fill Volume: 78.7 yds

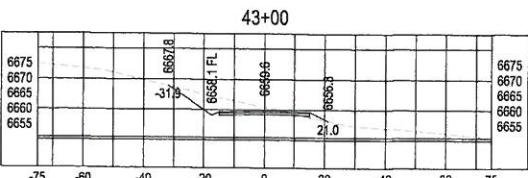

Cut Area: 133 ft<sup>2</sup>  
Fill Area: 6 ft<sup>2</sup>  
Cut Volume: 3489.9 yds  
Fill Volume: 95.4 yds

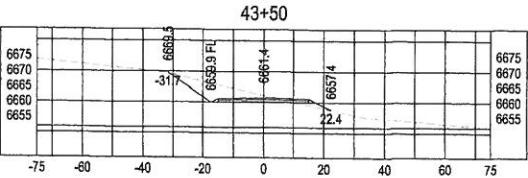






Cut Area: 123 ft<sup>2</sup>  
Fill Area: 10 ft<sup>2</sup>  
Cut Volume: 3727.4 yds  
Fill Volume: 110.6 yds

PRELIMINARY



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Fax: (970) 385-4602

**ANIMAS GLACIER GRAVEL PIT  
CROSS SECTIONS**

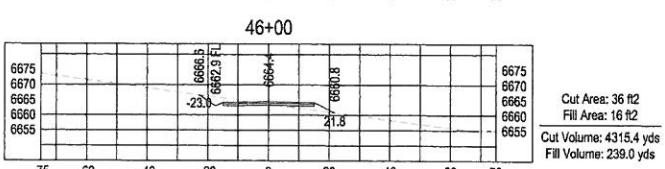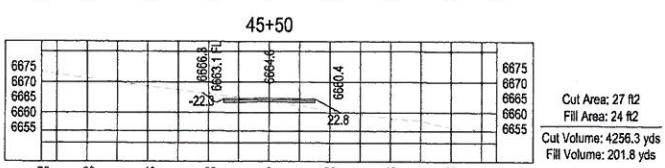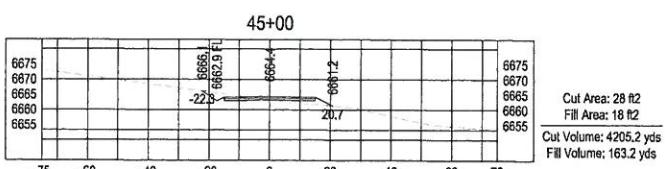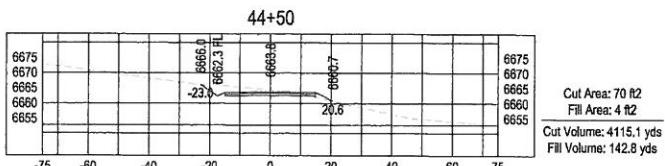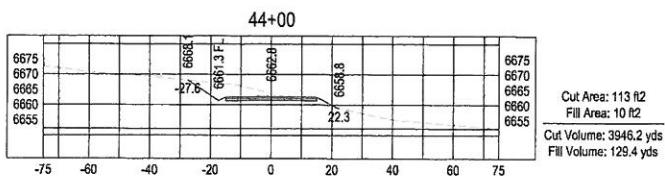ACAD FILE:  
REVISIONS:

Drawn/Checked: SW  
Drafted by:  
DATE: 05-04-2012  
PROJECT: ANIMAS GLACIER  
GRAVEL PIT

PRELIMINARY