UNFACTORED BASE REACTIONS TO

CONSIDER AT TYPICAL BASES

Side B

Side A

*See notes below	ADDITIONAL UNFACTORED BASE REACTIONS TO CONSIDER AT BASES WITH CABLE ATTACHED							
Load Case		Side A				Side B		
Load Case		Rx (kip)	Ry (kip)	Rz (kip)	Rx (kip)	Ry (kip)	Rz (kip)	
Wind Load	Wz	-2.42	-9.84	-2.40	2.87	-8.57	-1.91	
Dead Load, Cable (Wz)	DL	0.00	0.01		0.00	0.01		
Wind Load	Wz2	2.14	3.69	0.05	-0.03	-0.10	0.08	
Dead Load, Cable (Wz2)	DL	0.01	0.02		-0.01	0.02		

#### STRUCTURAL DESIGN LOADS

IBC 2021; ASCE 7-16 Risk Category II

\*See notes below

Wind Speed Vult = 100 mph, Exposure C Wind Pressure (q) = 21.8xKz psf

Ground Snow Load = 60 psf Thermal Factor Ce = 1.0. Ct = 1.20Snow Importance Factor = 1.0 Flat Roof Snow (Pf) = 50.4 psf

Seismic Design Category C  $S_s = 0.391q$ ,  $S_1 = 0.082q$  $Sd_1 = 0.131q$ , Sds = 0.384q

> BEFORE YOU DIG CALL: 1-800-922-1987 www.uncc.org Utility Notification Center of Colorado

5173 HIGHWAY 133 SOMERSET, CO 81434 GUNNISON COUNTY

PROJECT NUMBER: FTK.25.001 FOUNDATION DRAWING FOR 56' X 60' LONG FARMTEK CLEARSPAN BUILDING 3,360 SF

ISSUED FOR REVIEW: 10 JANUARY 2025

#### INDEX OF DRAWINGS

C-1 COVER SHEET & INDEX OF DRAWINGS

S-1 FOUNDATION PLAN

S-2 MIDDLE LAYER & ENDWALL ELEVATIONS

S-3 SIDEWALL ELEVATION

S-2 CONCRETE BLOCK & MISC. DETAILS

S-3 ANCHOR & BASE PLATE LAYOUT

#### GENERAL

Building End Use: Workshop Use Group: F−1 Moderate Hazard Factory Construction Type: IIB-Membrane Fabric Building

#### A. GENERAL REQUIREMENTS

- 1. All work shall be done per OSHA standards and regulations.
- 2. Obtain prior approval from Owner when substituting materials or equipment.
- 3. Work shall conform to all governing codes.
- 4. Establish locations of underground utilities (provided by others).
- 5. Servinsky Engineering & Associates is not responsible for vehicle impact to building.

#### B. EARTHWORK AND DRAINAGE

1. Cap off or plug discontinued utilities in excavations and remove from site.

- 2. When required by site drawings, provide drain pipe to divert storm water and roof drainage away from foundation.
- 3. Backfill shall be clean, granular backfill compacted per the geotechnical report.
- 4. Compact to 98 percent of maximum dry density per ASTM D-1557 Modified Proctor Density Test.
- 5. Compact fill in 8" to 10" lifts.
- 6. Remove unsuitable materials to firm soil.
- 7. Slope finish grade away from structure on all sides for positive drainage. 5 percent for the first 10 feet away from structure.
- 8. If rock is encountered during excavation, contact Engineer before proceeding with work.
- 9. Provide final grading, topsoil, gravel, compaction and seeding as necessary within affected area of building. Fill and Compact to 100% of standard Proctor Density.

#### C. CONCRETE FOR PRECAST BLOCKS

- 1. 28 day minimum compressive strength: 2500 psi.
- 2. Precast blocks to be 2 feet x 2 feet x 6 feet long, unless noted on drawings. Local precast supplier to form and pour blocks using industry accepted standards and quality control methods. Blocks to have continuous shear key.
- 3. Prevent spalling or honeycombing of concrete in precast blocks.
- 4. Repair any spalled areas of blocks with EMACO S488 by BASF Company. Spalls are identified as broken concrete edges 1"x3" or larger size. Repair spalls within 12" of anchor locations.

#### D. BUILDING SPECIFICATIONS

1. Building specifications are per FarmTek, under separate submittal. Roof fabric is per manufacturer.

#### E. FDN. DESIGN PARAMETERS

- 1. Design Bearing Capacity = 2000 psf, presumptive per IBC, granular materials.
- 2. No geotechnical report is available.

BLOCK LENGTH	NO.
6'	118
4'	2
3'	10
2'	3

		REVISIONS			] .
BY	REV	DESCRIPTION	DATE	APPROVED	Ī
MS	0	ISSUED FOR REVIEW	1/10/25	BSJ	4

SERVINSKY ENGINEERING & ASSOCIATES Consulting Structural Engineers 280 Douglas Ave Holland, MI 49424-6515 (616) 738–1281 Fax (616) 738–6281

COVER SHEET & INDEX OF DRAWINGS

GUNNISON COUNTY


FARMTEK CLEARSPAN 1440 FIELD OF DREAMS WAY DYERSVILLE, IA 52040

SOMERSET, CO SCALE: 1'' = 1' - 0''

DWG FTK.25.001

SHEET NO:

SHEET SIZE: C-1

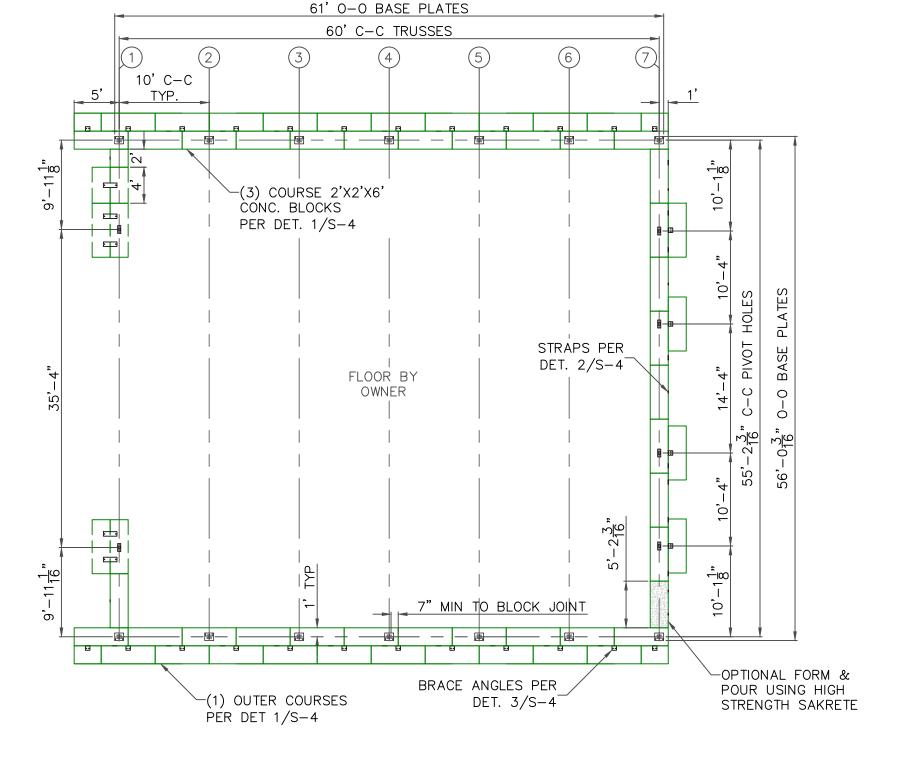

		REVISIONS			
BY	REV	DESCRIPTION	DATE	APPROVED	ì
MS	0	ISSUED FOR REVIEW	1/10/25	BSJ	ı

& ASSOCIATES Consulting Structural Engineers FARMTEK CLEARSPAN

SERVINSKY ENGINEERING

1440 FIELD OF DREAMS WAY

DYERSVILLE, IA 52040

280 Douglas Ave Holland, MI 49424-6515 (616) 738-1281 Fax (616) 738-6281

FOUNDATION PLAN

DWG FTK.25.001


SCALE: 3/32" = 1'-0"

SOMERSET, CO

GUNNISON COUNTY SHEET S-1


SHEET B


 $\stackrel{\times}{\geq}$ 

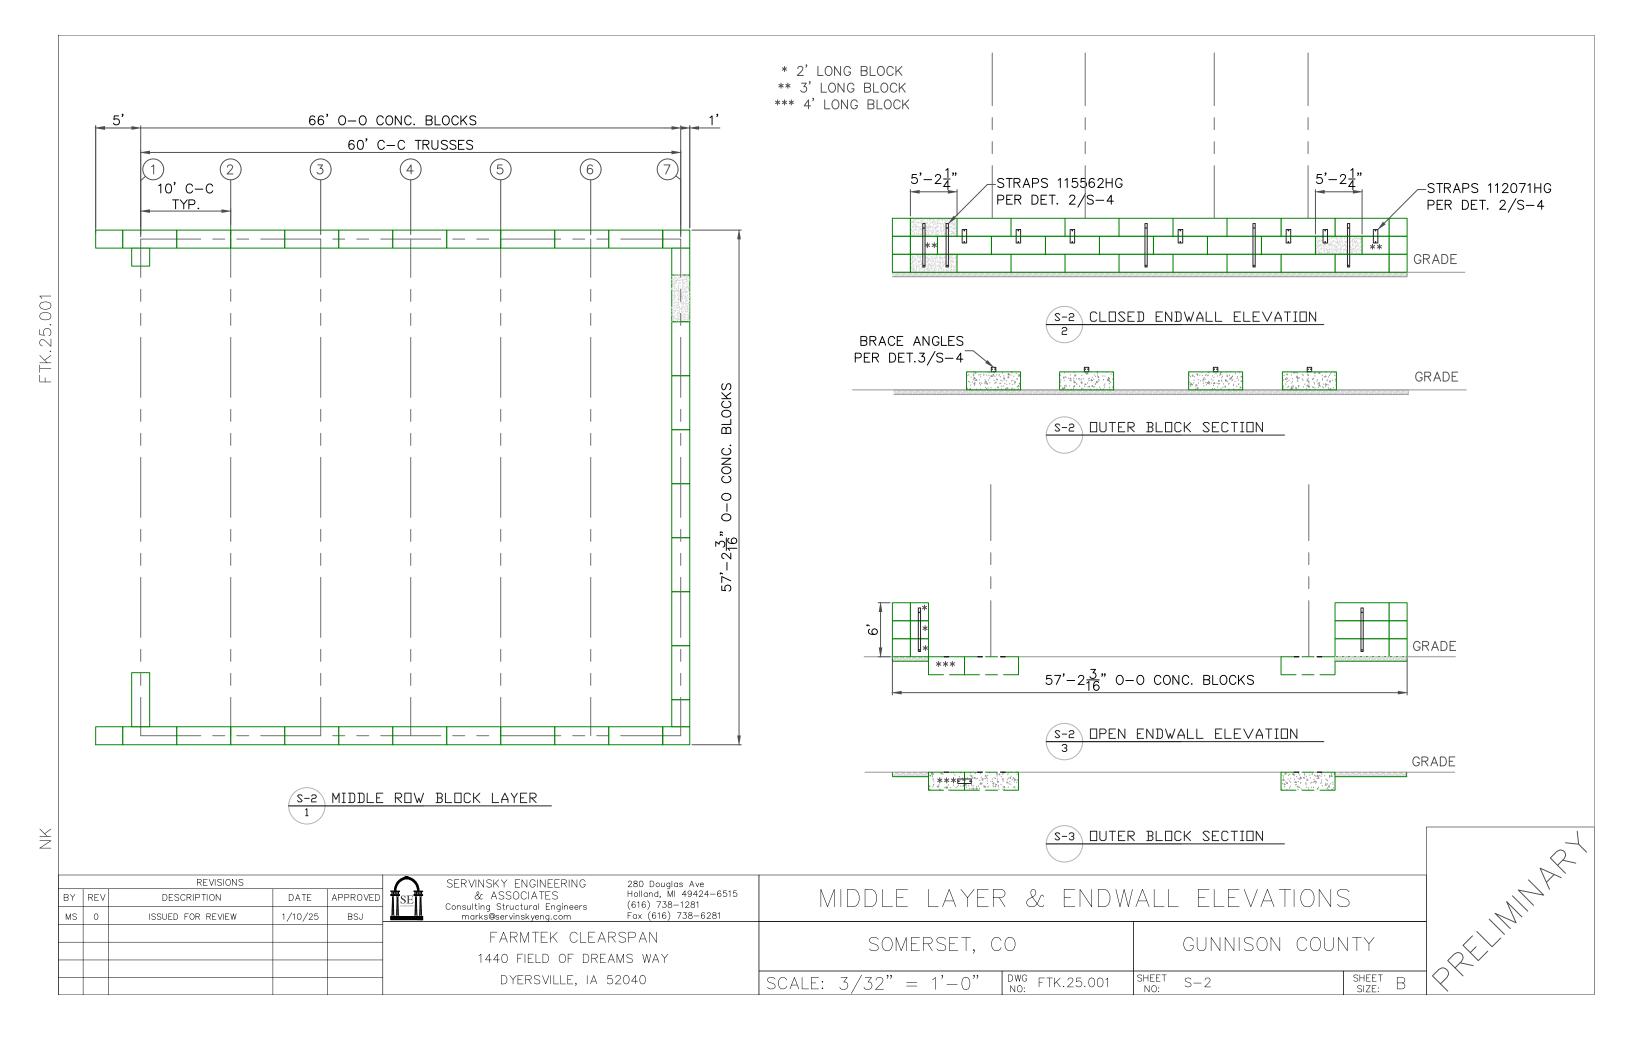

OPPOSITE SIDEWALL IS MIRROR IMAGE

\*\* 3' LONG BLOCK

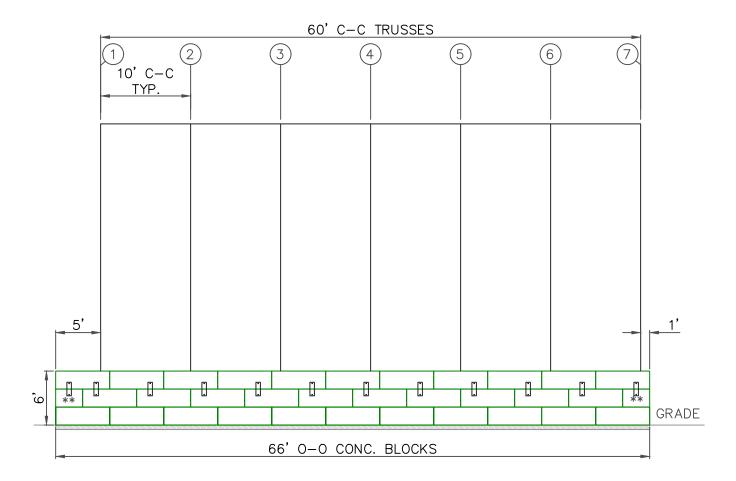

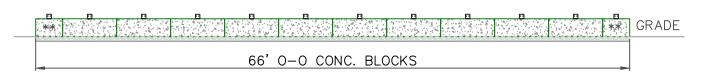

S-3 DUTER BLOCK SECTION

PPROVED
BSJ

SERVINSKY ENGINEERING
& ASSOCIATES
Consulting Structural Engineers
marks@servinskyeng.com

280 Douglas Ave Holland, MI 49424-6515 (616) 738-1281 Fax (616) 738-6281

SIDEWALL ELEVATION

DWG FTK.25.001

FARMTEK CLEARSPAN

1440 FIELD OF DREAMS WAY

DYERSVILLE, IA 52040


SOMERSET, CO

SCALE: 3/32" = 1'-0"

GUNNISON COUNTY

SHEET S-3


SHEET B

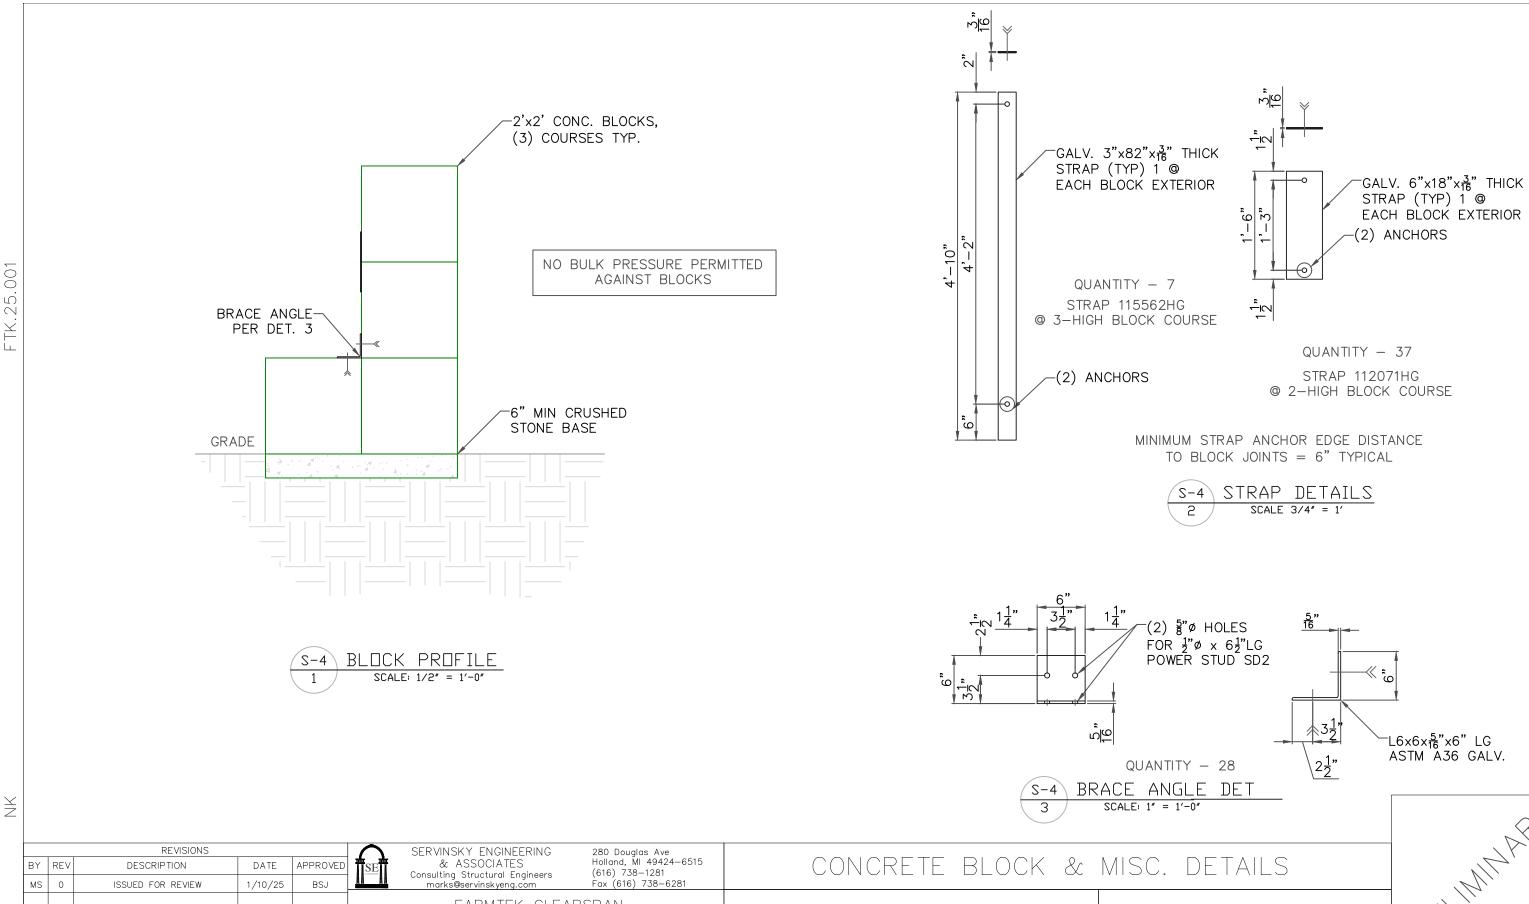

FARMTEK CLEARSPAN GUNNISON COUNTY SOMERSET, CO 1440 FIELD OF DREAMS WAY SHEET S-4 SHEET SIZE: DWG FTK.25.001 DYERSVILLE, IA 52040 SCALE: AS NOTED

В



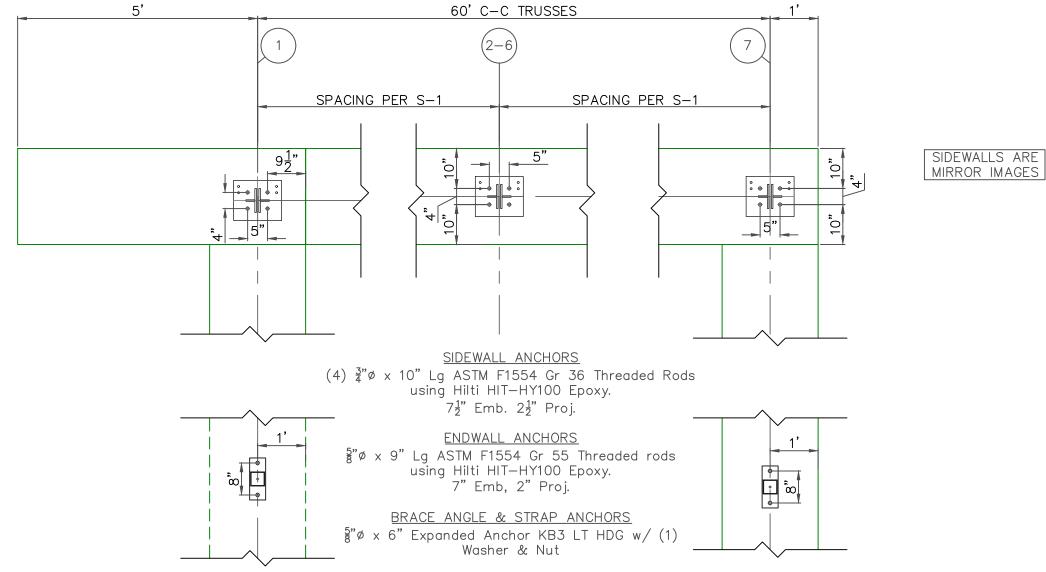

Install per Manufacturers Specifications.

Minimum sidewall anchor distance to block joint = 7" Contact Engineer of Record if distance is not met.

l					
		REVISIONS			
BY	REV	DESCRIPTION	DATE	APPROVED	Ī
NK	0	ISSUED FOR REVIEW	1/10/25	BSJ	į

SERVINSKY ENGINEERING
& ASSOCIATES
Consulting Structural Engineers
marks@servinskyeng.com

280 Douglas Ave Holland, MI 49424-6515 (616) 738-1281 Fax (616) 738-6281

ANCHOR & BASE PALTE LAYOUT

FARMTEK CLEARSPAN

1440 FIELD OF DREAMS WAY

DYERSVILLE, IA 52040

SOMERSET, CO

SCALE: 1/2" = 1'-0"

DWG FTK.25.001

GUNNISON COUNTY

SHEET S-5

SHEET SIZE: B

#### NOTES:

LINE STYLES:

COLUMN:

2" X 3" TUBE:

2" X 4" TUBE:

- ALL DIMENSIONS ARE FROM CENTER TO CENTER UNLESS OTHERWISE NOTED.
- FRAMING FOR VENTS AND ADDITIONAL FRAMING, IF REQUIRED, WILL BE CUT IN FIELD USING 2" X 3" RECT. TUBE AND USE INSERTS [107923] OR [110356ALT/110356BALT].
- FRAMING FOR WALK DOORS, IF REQUIRED, WILL BE CUT IN FIELD USING 2" X 4" RECT. TUBE AND USE INSERTS [115790] OR [110356ALT/110356BALT].

LOCATIONS CAN BE FIELD ADJUSTED +/- 12" FROM WHAT IS SHOWN.

FOUNDATION ELEMENTS ARE NOT SHOWN.

WARNING: Cancer and Reproductive Toxicity - P65Warnings.ca.gov

HEADER: -----TELESCOPING PURLIN:-----

DIMENSIONS FOR TELESCOPING PURLIN LOCATIONS ARE APPROXIMATE.

FRAME-OUT	SCHEDULE	
CALL-OUT	DESCRIPTION	ROUGH OPENING
Α	35'-0" X 20'-0" FABRIC GATHERING DOOR	35'-0" X 20'-0"
В	3'-0" X 6'-8" WALK-IN DOOR	39-15/16" X 81-5/8"


# **EW056RKF0941D**

### **NORTHWEST ENDWALL CONTENT GUIDE:**

.COVER SHEET/PART LOCATIONS/LAYOUT

.CONNECTION DETAILS

.KICKBACK CONNECTION DETAILS

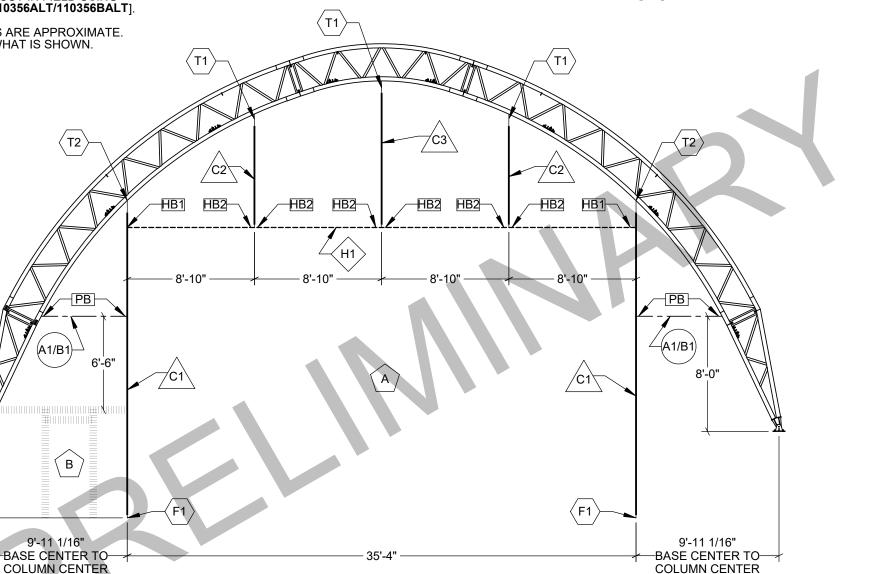

4" X 4", 8 GA, 3-PLY SQUARE TUBE

C1: **EWC3P252G08** 4" X 4", 8 GA, 1-PLY SQUARE TUBE

> C2: EWM1P082G08 C3: EWM1P110G08

→ HEADERS

6'-0"

BASE BOTTOM TO **COLUMN BOTTOM** 

4" X 4", 8 GA, 3-PLY SQUARE TUBE

H1: EWH3P41875G08

(T2)

A1/B1

(в)

9'-11 1/16"

2.375" OD. 14 GA ROUND PIPE

A1: 200TP050

2.0" OD, 11 GA ROUND PIPE

TELESCOPING PURLINS

B1: 2375TP050

⟨ NSERTS

TOP COLUMN INSERTS (3.5" SQ. TUBE / 1/2" STEEL PLATE)

> T1: 108151SAS01/108151SB T2: 108151SAS01/108151SB

**BOTTOM COLUMN INSERTS** (3.5" SQ. TUBE / 1/2" STEEL PLATE)

F1: 111700

**BRACKETS** 

PURLIN BRACKET (1/8" STEEL PLATE)

PB: **106755** 

HEADER BRACKET (3/16" STEEL PLATE)

HB1: EWHB3P HB2: EWHB1P

CUSTO	OMER DESIGN APPROVAL	
CUSTOMER SIGNATURE		
DATE	APPROVE WITH CHANGES	_ APPROVE

COVER/TERMINATION DETAILS: NON FIRE-RATED, POUND IN STRIP, WHITE, 12oz,


SHEET: L1

NOT TO SCALE SHEET SIZE: 11X17

REVISIONS:

**ClearSpan** ORDER # 7888719 CUSTOMER #:

DBW	CUSTOMER INFORMATION:		STRUCTURE SKU # EW056RKF0941D
VING DET/	CUSTOMER CONTACT:	CONTACT PHONE: STRUCTURE SIZE: 56' X 60'	STRUCTURE SZE: 56' X 60'
UI S	SHEET TITLE: COVER SHEET/PART LOCATIONS/LAYOUT	IONS/LAYOUT	STRUCTURE DESCRIPTION:

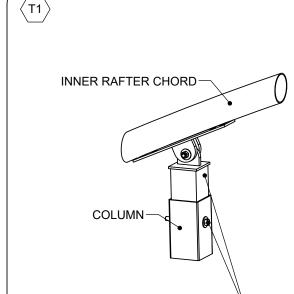


ADJUSTABLE TOP COLUMN INSERT - (1X) 1/2" X 2 1/2" HEX BOLT (HINGE BOLT)

- (4X) 1/2" WASHER (STRUCTURAL) - (2X) 1/2" HEX NUT (STRUCTURAL) - (2X) 3/8" BOX BOLT (THRU CHORD)

- (1X) 1/2" X 5 1/2" HEX BOLT (THRU COLUMN) (À325)

### **VIEW 1: ADJUSTABLE TOP COLUMN INSERT DETAIL @ C2 & C3**

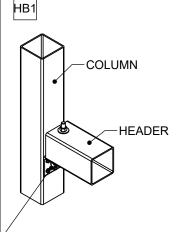

**HEADER BRACKET** 


- (SEE CHART) 1/2" X 5 1/2" HEX BOLT (A325)
- (SEE NOTE) 1/2" WASHER (STRUCTURAL) - (SEE NOTE) 1/2" HEX NUT (STRUCTURAL)
- (SEE CHART) #14 X 1" TEK SCREW

NOTE: EVERY BOLT WILL GET (2) WASHERS AND (1) HEX NUT. SEE CHART FOR # OF BOLTS

BRACKET SKU	# OF BOLTS	# OF TEK SCREWS
EWHB1P	2	4
EWHB2P	4	8
EWHB3P	6	8

**VIEW 6: HEADER BRACKET DETAIL** 



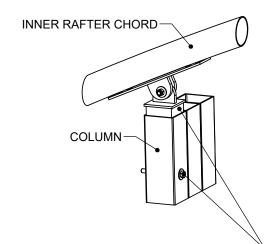


ADJUSTABLE TOP COLUMN INSERT - (1X) 1/2" X 2 1/2" HEX BOLT (HINGE BOLT)

- (4X) 1/2" WASHER (STRUCTURAL) - (2X) 1/2" HEX NUT (STRUCTURAL)

- (2X) 3/8" BOX BOLT (THRU CHORD) - (1X) 1/2" X 5 1/2" HEX BOLT (THRU COLUMN) (A325)


### **VIEW 2: ADJUSTABLE TOP COLUMN INSERT DETAIL @ C1**

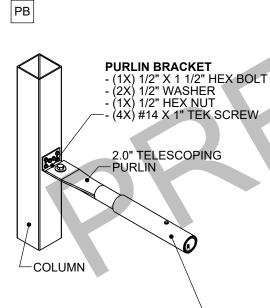

2.375" TELESCOPING PURLIN - (2X) #14 X 1" TEK SCREW\*

\*NOTE: (1X) EACH ON OPPOSING FACE FROM THE OTHER.

**VIEW 7: PURLIN BRACKET DETAIL** 

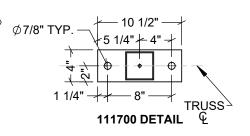

**COLUMN BRACKET TO COLUMN** - (2X) 5/16" BOX BOLT-

WINCH TO COLUMN BRACKET -COLUMN - (2X) 1/2" X 1 1/2" HEX BOLT

- (2X) 1/2" WASHER - (2X) 1/2" HEX NUT WINCH TO COLUMN BRACKET [116659] PLACE WINCH TO **COLUMN BRACKET** 


TO ALLOW CLEARANCE

OF FOUNDATION

**BOTTOM COLUMN INSERT** 

- (1X) 1/2" X 5 1/2" HEX BOLT (A325) - (2X) 1/2" WASHER (STRUCTURAL) - (1X) 1/2" HEX NUT (STRUCTURAL)


**VIEW 3: BOTTOM COLUMN INSERT DETAIL @ C1** 

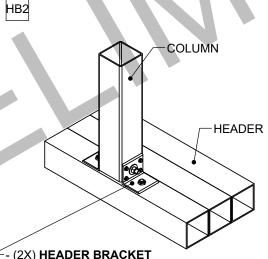


- (SEE CHART) 1/2" X 5 1/2" HEX BOLT (A325) (THRU COLUMN)
- (SEE NOTE) 1/2" WASHER (STRUCTURAL) (SEE NOTE) 1/2" HEX NUT (STRUCTURAL)
- (SEE CHART) #14 X 1" TEK SCREW
- (SEE CHART) 5/16" BOX BOLT (THRU HEADER)

BRACKET SKU	# OF BOLTS	# OF TEK SCREWS	# OF BOX BOLTS
EWHB1P	1	4	2
EWHB2P	2	8	4
EWHB3P	3	8	6

**VIEW 8: PARTIAL ENDWALL COLUMN BRACKET DETAIL** 

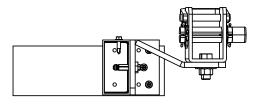

**COLUMN BRACKET TO TUBE** - (2X) 5/16" BOX BOLT

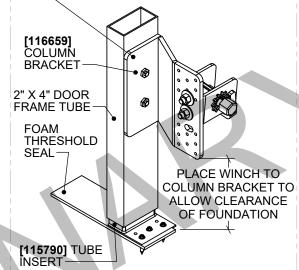

**VIEW 4: COLUMN BRACKET TO** WALK-IN DOOR FRAME DETAIL

\*NOTE: REFER TO SHEET [L1] LINE STYLES LEGEND FOR TUBE SIZE.

-INNER RAFTER CHORD


—2" X 3" / 2" X 4" TUBE\* (CUT TO LENGTH IN FIELD)

✓ADJUSTABLE 2" X 3" / 2" X 4" INSERT [110356ALT/110356BALT]

- (1X) 1/2" X 2 1/2" HEX BÖLT (HINGE BOLT)(A325)

- (2X) 1/2" WASHER (STRUCTURAL) - (1X) 1/2" HEX NUT (STRUCTURAL)

- (2X) 5/16" BOX BOLT (THRU CHORD) - (2X) #14 X 1" TEK SCREW

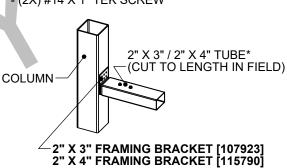

- (6X) #14 X 1" TEK SCREW VIEW 5: 2" X 3" / 2" X 4"

**INSERT DETAILS** 

BOX BOLT HOLE SIZES & INSTALLATION TORQUE		
BOX BOLT DIA.	HOLE DIA.	INSTALLATION TORQUE
1/4"	7/16"	14 FT-LB
5/16"	9/16"	18 FT-LB
3/8"	3/4"	33 FT-LB
1/2"	13/16"	59 FT-LB
5/8"	1-1/16"	140 FT-LB
3/4"	1-5/16"	221 FT-LB
		CHNICAL DATA FOR MORE JSING BOX BOLTS

STRUCTURE SKU # EW056R KF0941D	CONTACT PHONE: STRUCTURE SIZE: 56' X 60'	STRUCTURE DESCRIPTION:
	CONTACT PHONE:	
CUSTOMER INFORMATION:	CUSTOMER CONTACT:	SHEET TITLE: CONNECTION DETAILS

ClearSpan

ORDER:


CUSTOMER #:

DIVISION OF NGINEERING SERVICES & PRODUCTS CO

7888719

DRAWING DETAILS				
	DRA'	WN BY:	CREATION DATE: 12/30/2024	
ı		REVIS	IONS:	
ı	NO.	BY:	REVISION DATE:	
STANDARD V2.2"	1			
	2			
LANDA	3			
ATES	4			
TEMPLATE	NO	T TO SCALE	SHEET SIZE: 11X17	
ľ	SHEET:			

L2

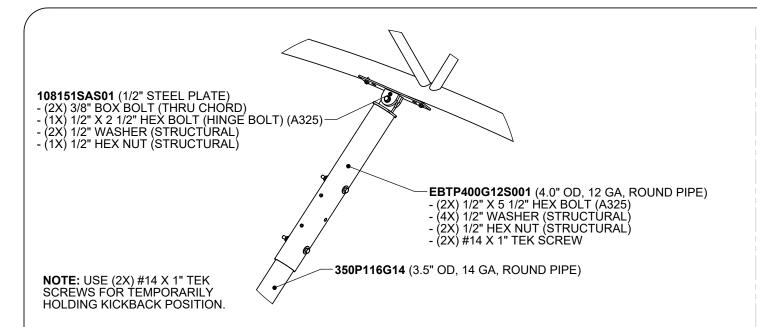


**VIEW 1: KICKBACK CONNECTION DETAILS** 


## STEEL PLATE

- (2X) 1/2" X 5 1/2" HEX BOLT (HINGE BOLT) (A325)
- (1X) 1/2" WASHER (STRUCTURAL)
- (3X) 1/2" HEX BOLT (A325)
- (3X) 1/2" HEX NUT (STRUCTURAL)
- (3X) 1/2" WASHER (STRUCTURAL)
- (2X) 1/2" X 5 1/2" HEX BOLT (A325)
- (4X) 1/2" WASHER (STRUCTURAL)
- (2X) 1/2" HEX BOLT (A325)
- (4X) 1/2" WASHER (STRUCTURAL)
- (2X) 1/2" HEX NUT (STRUCTURAL)

**VIEW 2: KICKBACK CONNECTION DETAILS AT COLUMN** 

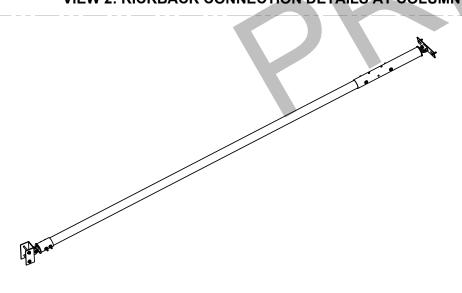

**VIEW 3: TYPICAL KICKBACK ASSEMBLY** 

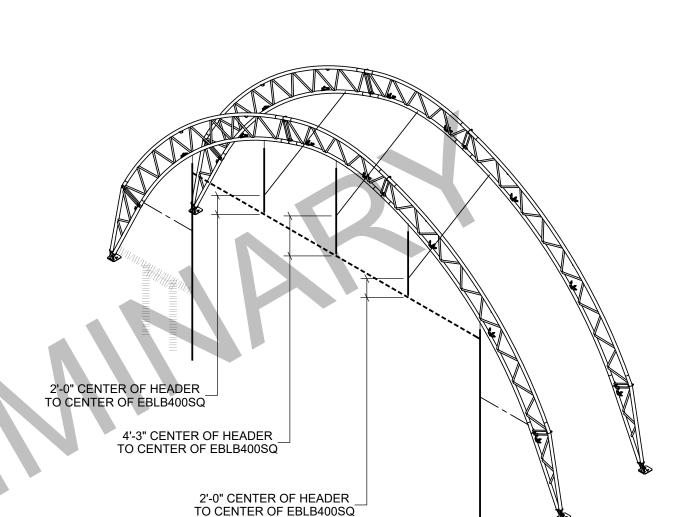

NOTE: LATERAL AND ANGLED BRACES NOT SHOWN FOR CLARITY.



l		DRAWING	DETAILS
	DRAWN BY: GLB		CREATION DATE: 12/30/2024
l		REVIS	IONS:
l	NO.	BY:	REVISION DATE:
l	1		
l	2		
l	3		
l	4		
l	NOT TO SCALE		SHEET SIZE: 11X17
	SHEET:		
/		L	3 /

#### NOTES:

- ALL DIMENSIONS ARE FROM CENTER TO CENTER UNLESS OTHERWISE NOTED.
- FRAMING FOR VENTS AND ADDITIONAL FRAMING, IF REQUIRED, WILL BE CUT IN FIELD USING 2" X 3" RECT. TUBE AND USE INSERTS [107923] OR [110356ALT/110356BALT].
- FRAMING FOR WALK DOORS, IF REQUIRED, WILL BE CUT IN FIELD USING 2" X 4" RECT. TUBE AND USE INSERTS [115790] OR [110356ALT/110356BALT].
- DIMENSIONS FOR TELESCOPING PURLIN LOCATIONS ARE APPROXIMATE. LOCATIONS CAN BE FIELD ADJUSTED +/- 12" FROM WHAT IS SHOWN.

10'-1 1/16"


BASE CENTER TO-

COLUMN CENTER



### LINE STYLES:

WARNING: Cancer and Reproductive Toxicity - P65Warnings.ca.gov

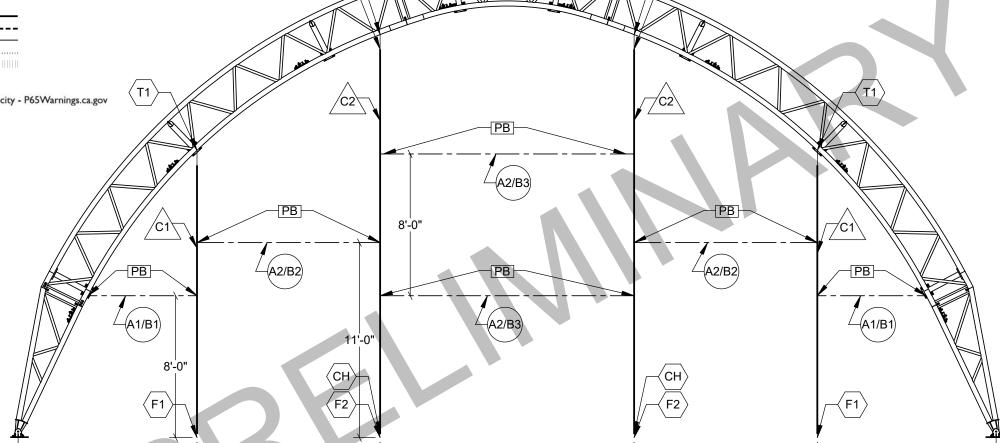

## $\wedge$ columns

4" X 4", 8 GA, 1-PLY SQUARE TUBE

C1: **EWC1P182G08** 

8" X 4", 8 GA, 1-PLY RECT. TUBE

C2: EWC8X4G08L260

# TELESCOPING PURLINS

2.0" OD, 11 GA ROUND PIPE

A1: **200TP050** A2: **200TP060** 

2.375" OD, 14 GA ROUND PIPE

B1: **2375TP050** B2: **2375TP085** B3: **2375TP138** 

# 

TOP COLUMN INSERTS (3.5" SQ. TUBE / 1/4" STEEL PLATE)

T1: 108151SA/108151SB T2: 108151SA/108151SB

BOTTOM COLUMN INSERTS (3.5" SQ. TUBE / 1/2" STEEL PLATE)

> F1: **111700** F2: **111700**

"C" CHANNEL INSERTS (1/8" STEEL PLATE)

CH: **111260** 

## BRACKETS

PURLIN BRACKET (1/8" STEEL PLATE)

10'-1 1/16"

BASE CENTER TO-

**COLUMN CENTER** 

PB: **106755** 

## **CUSTOMER DESIGN APPROVAL**

CUSTOMER SIGNATURE

DATE APPROVE WITH CHANGES APPROVE

COVER/TERMINATION DETAILS: NON FIRE-RATED, POUND IN STRIP, WHITE, 12oz

ClearSpan

Commission of the c

CUSTOMER #:

**EW056RKF0950D** 

SOUTHEAST ENDWALL CONTENT GUIDE:

[M2] ......CONNECTION DETAILS

[M1] ......COVER SHEET/PART LOCATIONS/LAYOUT


CUSTOMER INFORMATION:		STRUCTURE SKU #: EW056RKF0950D
CUSTOMER CONTACT:	CONTACT PHONE: STRUCTURE SIZE:	STRUCTURE SIZE:
SHEET TITLE. COVER SHEET/PART LOCATIONS/LAYOUT	IONS/LAYOUT	STRUCTURE DESCRIPTION:

REVISIONS:


NOT TO SCALE SHEET SIZE: 11X17

М1

SHEET:

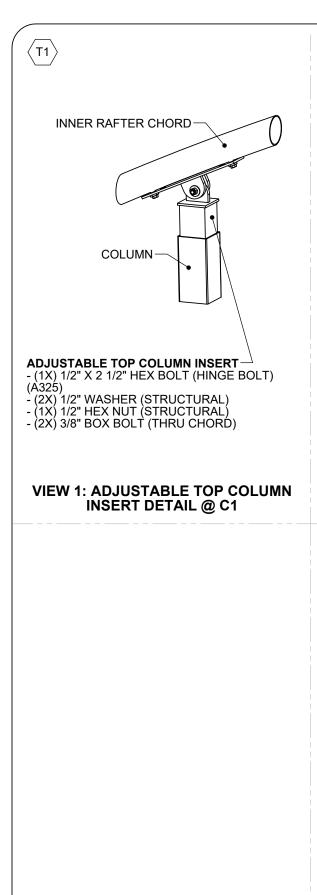

**VIEW 6: NOT USED** 

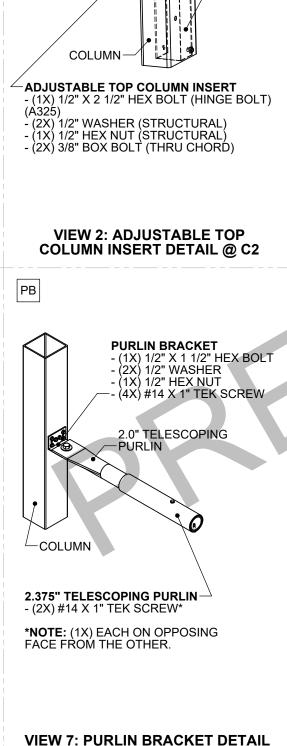


"C" CHANNEL INSERT (REFER TO VIEW 8)

 $\langle$  T2angle

**INNER RAFTER** 

CHORD-

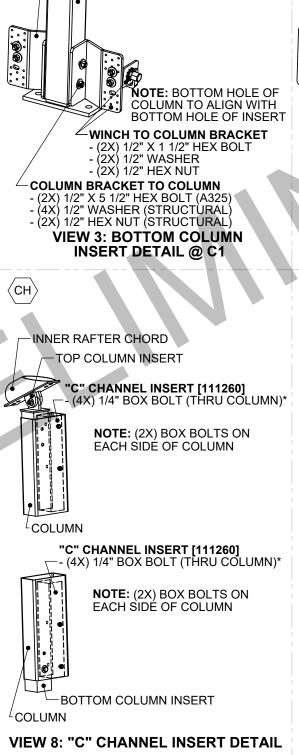

 $\emptyset$ 7/8" TYP.


WINCH TO COLUMN

-COLUMN

BRACKET [116659]

TRUSS -

111700 DETAIL

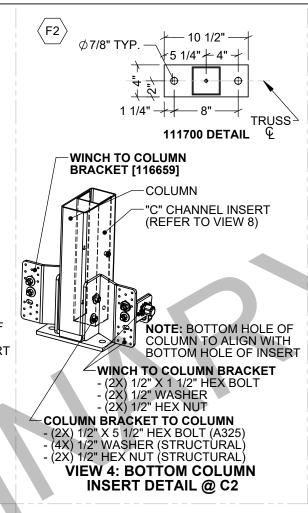

VIEW 5: NOT USED

BOX BOLT HOLE SIZES & INSTALLATION TORQUE		
BOX BOLT DIA.	HOLE DIA.	INSTALLATION TORQUE
1/4"	7/16"	14 FT-LB
5/16"	9/16"	18 FT-LB
3/8"	3/4"	33 FT-LB
1/2"	13/16"	59 FT-LB
5/8"	1-1/16"	140 FT-LB
3/4"	1-5/16"	221 FT-LB
1. REFER TO BOX BOLT TECHNICAL DATA FOR MORE INFORMATION IF USING BOX BOLTS		

CUSTOMER INFORMATION:		STRUCTURE SKU # EW056RKF0950D
CUSTOMER CONTACT:	CONTACT PHONE: STRUCTURE SIZE: 56' X 60'	STRUCTURE SIZE: <b>56' X 60'</b>
SHEET TITLE: CONNECTION DETAILS		STRUCTURE DESCRIPTION:

**ClearSpan** 

7888719

ORDER:

CUSTOMER #:

DRAWING DETAILS			
DRAWN BY: GLB		CREATION DATE: 12/30/2024	
REVIS		IONS:	
NO.	BY:	REVISION DATE:	
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NOT TO SCALE		SHEET SIZE: 11X17	
SH	SHEET:		


**M2** 

## **ADDITIONAL INFORMATION**

THESE PRINTS IDENTIFY AND SHOW THE MAIN COMPONENTS AND CONNECTIONS FOR THIS BUILDING. LENGTH, WIDTH, AND OTHER IMPORTANT DIMENSIONS ARE ALSO PRESENT.

TO BEST UNDERSTAND HOW TO CONSTRUCT THIS BUILDING, THE INFORMATION CONTAINED WITHIN THESE SHEETS SHALL BE USED WITH THE INSTRUCTION MANUAL SHIPPED WITH THE BUILDING.

THE INSTRUCTIONS INCLUDE DETAILS NEEDED DURING CONSTRUCTION.

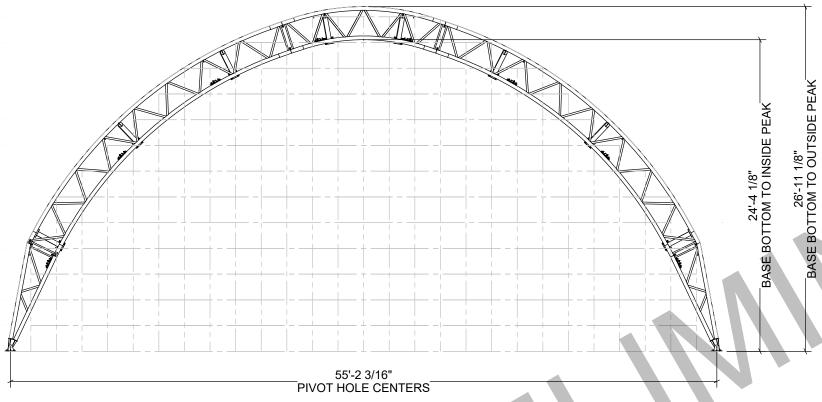

GRID SQUARES = 2'



WARNING: Cancer and Reproductive Toxicity - P65Warnings.ca.gov

# CUSTOMER DESIGN APPROVAL

PLEASE SIGN AND CHECK THE APPROPRIATE BOX BELOW THE SIGNATURE AFTER REVIEWING THE DOCUMENTS.

MY SIGNATURE BELOW ACKNOWLEDGES THAT I HAVE READ AND REVIEWED ALL THE SHEETS LISTED IN THE CONTENT GUIDE AND AGREE TO THE SPECIFICATIONS SHOWN UNLESS OTHERWISE NOTED.

UPON ACCEPTANCE OF THE DRAWINGS, ANY DEVIATIONS FROM THE SIGNED DRAWINGS AND SPECIFICATIONS OUTLINED IN THE EXECUTED DRAWINGS ARE SUBJECT TO ADDITIONAL CHARGES AND MAY RESULT IN DELAY OF INSTALLATION OR DELIVERY OF YOUR STRUCTURE. A CHANGE ORDER WILL BE ISSUED TO YOU WITH THE OUTLINED ADDITIONAL COST ASSOCIATED WITH THESE CHANGES AND A PROPOSED NEW DELIVERY SCHEDULE.

NO CHANGES WILL BE ACCEPTED UNLESS WE HAVE A CHANGE ORDER SIGNED BY AN AUTHORIZED REPRESENTATIVE.

FIRE-RATED OR NON FIRE-RATED	NON FIRE-RATED	
TERMINATION OF FABRIC	POUND IN STRIP	
FABRIC COLOR	WHITE	
WEIGHT OF MATERIAL	12	OZ.
\		

CUSTOMER SIGNATURE

DATE

APPROVE

APPROVE WITH CHANGES

# T056RKMF062060

## **BUILDING CONTENT GUIDE:**

	[A1]	COVER SHEET
	[B1]	GENERAL NOTES
	[C1]	BUILDING PLAN VIEW
	[D1]	MATERIAL SPECIFICATIONS
	[E1]	RAFTER PROFILES
	[F1]	SIDE PROFILES
	[G1]	DETAIL LOCATIONS & BASE DETAILS
	[G2]	.GENERAL CONNECTION DETAILS
	[G3]	.CABLE LAYOUT & DETAILS
-	[H1]	BASE PLATE LAYOUT & DETAILS
	[1]	OMITTED
	[J1]	BUILDING REACTION DATA
	[K]	OMITTED
	[L1 - L3]	NORTHWEST ENDWALL: EW056RKF0941D
	[M1 - M2]	SOUTHEAST ENDWALL: EW056RKF0950D



12060		RIPTION:
STRUCTURE SKU # T056RKMF062060	CONTACT PHONE: STRUCTURE SIZE: 56' X 60'	STRUCTURE DESCRIPTION:
	CONTACT PH	
CUSTOMER INFORMATION:	CUSTOMER CONTACT:	SHEET TITLE: COVER SHEET

ı			
		DRAWING	DETAILS
	DRAWN BY: GLB		CREATION DATE: 12/30/2024
		REVIS	SIONS:
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<b>TEMPLATE V2.2</b>	NOT TO SCALE		SHEET SIZE: 11X17
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		Δ	.1 /

#### **GENERAL NOTES:**

#### **FOUNDATION:**

1. FOUNDATION AND ANCHORING ARE NOT ADDRESSED BY THESE DRAWINGS.

#### **GENERAL ABBREVIATIONS:**

TOS TOP OF STEEL / TSL TOP OF SLAB / GALV. GALVANIZED / FND FOUNDATION / EL ELEVATION / RND. ROUND / GA GAUGE / DIA. DIAMETER / TYP. TYPICAL / LBS. POUNDS / **CL** CENTERLINE

#### **SITE CONDITIONS:**

1. NEITHER CLEARSPAN NOR THE BUILDING DESIGNER HAVE VISITED THIS JOBSITE. INFORMATION CONTAINED HEREIN IS BASED ON CLIENT SUPPLIED DATA AND MEASUREMENTS.

#### STEEL:

- 1. UNLESS OTHERWISE NOTED, ALL STRUCTURAL STEEL TUBING SHALL BE GALVANIZED. MIN. YIELD STRENGTH 50 KSI. AND SHALL MEET OR EXCEED THE REQUIREMENTS OF ASTM A500.
- 2. UNLESS OTHERWISE NOTED, STEEL PLATES SHALL COMPLY WITH ASTM A572 GRADE 50 OR EQUAL FOR 3/16" OR GREATER THICKNESS AND ASTM A1011 GRADE 50 OR ASTM A653 GRADE 50 OR EQUAL FOR LESS THAN 3/16" THICKNESS.
- 3. ALL STRUCTURAL STEEL IS TO BE FABRICATED IN ACCORDANCE WITH THE LATEST EDITION OF AISC "SPECIFICATION FOR THE DESIGN, FABRICATION AND ERECTION OF STRUCTURAL STEEL FOR BUILDINGS."

#### **BOLTS:**

1. UNLESS OTHERWISE NOTED, ALL BOLTED CONNECTIONS SHALL USE SAE J429 GRADE 2 OR A307 OR BETTER BOLTS WITH COMPATIBLE WASHERS AND NUTS OF DIAMETERS INDICATED ON PLANS. BOLTS NEED ONLY BE TIGHTENED TO THE SNUG-TIGHT CONDITION. THE SNUG-TIGHT CONDITION IS DEFINED AS THE TIGHTNESS ATTAINED BY A FEW IMPACTS OF AN IMPACT WRENCH, OR THE FULL EFFORT OF A PERSON USING AN ORDINARY SPUD WRENCH.

#### **CABLES AND HARDWARE:**

- 1. ALL CABLE SHALL BE GALVANIZED STEEL, MULTIPURPOSE, 7X19 (UP TO 3/8" DIA.) OR 6X26 (1/2" DIA.) CLASS STRAND CORE COMMERCIAL GRADE, OF DIAMETER INDICATED.
- 2. CABLE SLEEVES SHALL BE INSTALLED PER MANUFACTURER'S RECOMMENDATIONS.
- 3. USE THIMBLES WITH CABLE SLEEVES IN ALL LOOP-END APPLICATIONS.
- 4. TENSION CABLES AT TURNBUCKLE TO TAUT CONDITION (STRAIGHT AND NOT SLACK OR LOOSE).
- 5. TIGHTEN CABLES SEQUENTIALLY TO AVOID TWISTING OR DEFORMING STRUCTURAL ELEMENTS DURING ERECTION. RECHECK PREVIOUSLY TIGHTENED CABLES UNTIL ALL CABLES ACHIEVE TAUT CONDITION.

SHACKLE WORKING LOADS

1.1 KIPS

3.9 KIPS

1/4" GALV.

1/2" GALV.

#### **WELDING:**

- 1. ALL WELDING SHALL BE IN ACCORDANCE WITH THE LATEST EDITION OF AWS D1.1 AND D1.3.
- 2. REFER TO AWS PUBLICATION D19.0-72: WELDING ZINC-COATED STEEL AND "WELDING GUIDELINES" PUBLISHED BY ALLIED TUBE AND CONDUIT-HARVEY ILLINOIS, FOR RECOMMENDED PROCESSES AND PRACTICES FOR WELDING GALVANIZED STEEL.
- 3. ALL SHOP WELDING IS TO BE PERFORMED BY CERTIFIED WELDERS.

#### **PAINTING AND TOUCH-UP:**

- 1. AFTER SHOP FABRICATION, PAINT ALL BARE STEEL, WELDS, AND ABRADED AREAS WITH COLD GALVANIZING COMPOUND CONSISTENT WITH GALVANIZED TUBE MANUFACTURER'S RECOMMENDATIONS FOR COLOR AND COMPOSITION. PRIOR TO TOUCH-UP, CLEAN WELDED AND ABRADED AREAS WITH A WIRE BRUSH. SURFACES MUST BE CLEAN AND OIL FREE.
- 2. AFTER FIELD INSTALLATION, TOUCH-UP ANY FIELD WELDS AND DAMAGED AREAS WITH COLD GALVANIZING COMPOUND.

#### **ERECTION AND FIELD QUALITY CONTROL:**

- THE ERECTOR IS RESPONSIBLE FOR DESIGNING AND FURNISHING ALL TEMPORARY BRACING, SHORING, AND/OR SUPPORT THAT MAY BE REQUIRED AS THE RESULT OF ERECTOR'S CONSTRUCTION METHODS AND/OR SEQUENCES. THE STRUCTURE IS DESIGNED TO FUNCTION AS A UNIT UPON COMPLETION. THE STRUCTURAL ENGINEER ASSUMES NO LIABILITY FOR THE STRUCTURE DURING ERECTION.
- 2. NO MODIFICATIONS OR ALTERATIONS (OTHER THAN THOSE SHOWN ON THE DRAWINGS) SHALL BE MADE IN ANY STRUCTURAL MEMBER OR CONNECTION WITHOUT THE WRITTEN APPROVAL OF THE DESIGN ENGINEER.

	OLT HOLE S LATION TO	
BOX BOLT DIA.	HOLE DIA.	INSTALLATION TORQUE
1/4"	7/16"	14 FT-LB
5/16"	9/16"	18 FT-LB
3/8"	3/4"	33 FT-LB
1/2"	13/16"	59 FT-LB
5/8"	1-1/16"	140 FT-LB
3/4"	1-5/16"	221 FT-LB
1. REFER TO BOX BOLT T	ECHNICAL DATA FO USING BOX BOLTS	OR MORE INFORMATION IF


	OLT HOLE : LATION TO	
BOX BOLT DIA.	HOLE DIA.	INSTALLATION TORQUE
1/4"	7/16"	14 FT-LB
5/16"	9/16"	18 FT-LB
3/8"	3/4"	33 FT-LB
1/2"	13/16"	59 FT-LB
5/8"	1-1/16"	140 FT-LB
3/4"	1-5/16"	221 FT-LB



ż	STRUCTURE SKU #  T056RKMF062060  CONTACT PHONE: STRUCTURE SIZE:  56' X 60'
SHEFTTILE: GENERAL NOTES	STRUCTURE DESCRIPTION:

	DRAWING	DETAILS
DRA' GLB	WN BY:	CREATION DATE: 12/30/2024
	REVIS	IONS:
NO.	BY:	REVISION DATE:
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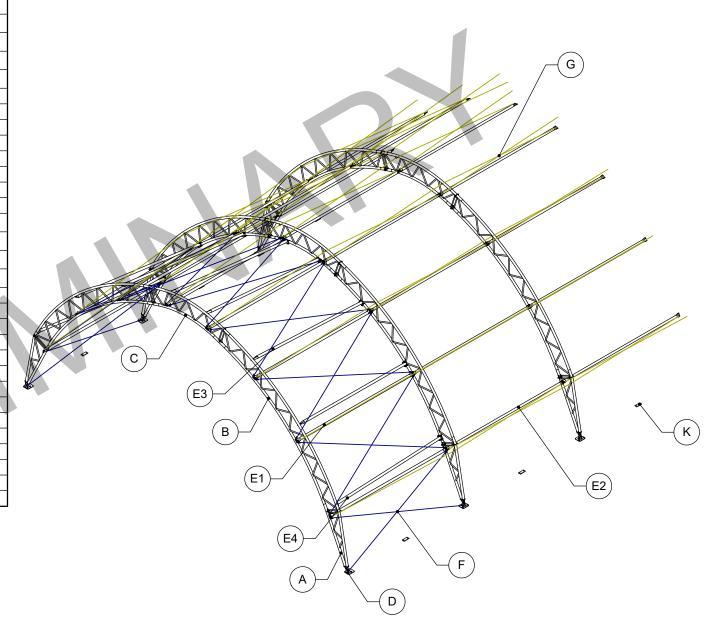
**B1** 

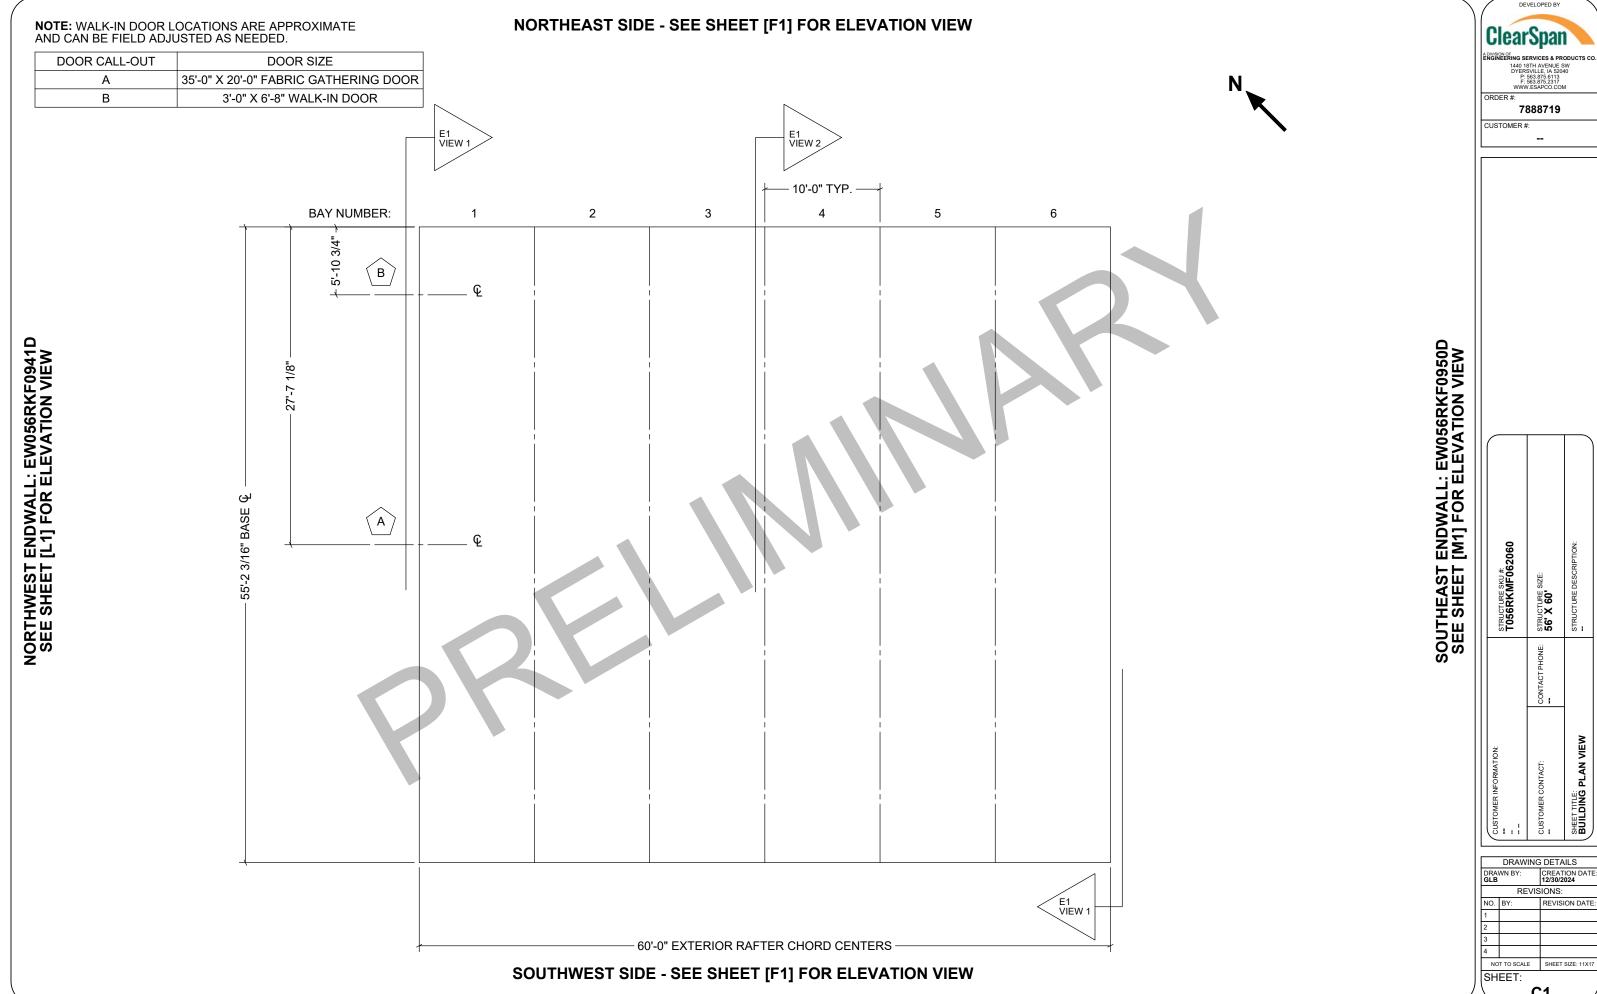

CUSTOMER CONTACT:  CUSTOMER CONTACT  CONTACT PHONE:  SHEET TITLE:  BUILDING PLAN VIEW  STRUCTURE SIZE:  56' X 60'  STRUCTURE SIZE:  56' X 60'  STRUCTURE DESCRIPTION:
---

C1

ITEM	DESCRIPTION	MATERIAL
Α	SUPPORT BASE	
	OUTER CHORD	GALV. RND. STEEL TUBE - $\emptyset$ 3.5" - 14 GA
	INNER CHORD	GALV. RND. STEEL TUBE - Ø 3.5" - 11 GA
	WEB (STRAIGHT)	GALV. RND. STEEL TUBE - $\phi$ 1.25" - 14 GA
	WEB (ANGLED)	GALV. RND. STEEL TUBE - $\phi$ 1.66" - 14 GA
	CONNECTION PLATES	STEEL PLATE, 1/2" THICK
	GUSSETS	STEEL PLATE, 3/8" THICK
	PIVOT PLATE (CHORD)	STEEL PLATE, 3/8" THICK
	PIVOT PLATE (ROUND)	STEEL PLATE, 1/2" THICK
B&C	SEGMENT	
	OUTER CHORD	GALV. RND. STEEL TUBE - Ø 3.5" - 11 GA
	INNER CHORD	GALV. RND. STEEL TUBE - Ø 3.5" - 11 GA
	WEB (STRAIGHT)	GALV. RND. STEEL TUBE - Ø 1.25" - 14 GA
	WEB (ANGLED)	GALV. RND. STEEL TUBE - $\phi$ 1.66" - 14 GA
	CONNECTION PLATES	STEEL PLATE, 1/2" THICK
	GUSSETS	STEEL PLATE, 3/8" THICK
D	BASES	
	HORIZONTAL	STEEL PLATE, 1/2" THICK
	VERTICAL (ROUNDED)	STEEL PLATE, 3/8" THICK
	THREADED STUDS	CFL FULLY THREADED STUD - 1/2"-13 x 1"
	GUSSETS	STEEL PLATE, 3/8" THICK
E	BRACING	
E1	LATERAL BRACING (END)	GALV. RND. STEEL TUBE - ∅ 2.875" - 14 GA
E2	LATERAL BRACING (MID)	GALV. RND. STEEL TUBE - ∅ 2.875" - 14 GA
E3	ANGLED BRACE	GALV. RND. STEEL TUBE - Ø 3.50" - 14 GA
E4	BOTTOM ANGLED BRACE	GALV. RND. STEEL TUBE - $\phi$ 3.50" - 14 GA
	THREADED STUD PLATE	1/4" PLATE W/ 1/2" X 2" STUDS
F	CABLE ASSEMBLY	SEE SHEET G3
	CABLE CONNECTION PLATE	STEEL PLATE, 5/16" THICK
G	SWAY CABLE ASSEMBLY	SEE SHEET G3
	CABLE CONNECTION PLATE	STEEL PLATE, 1/8" THICK
Н	BRACE PLATES	
	SUPPORT BASE TO SEGMENT	STEEL PLATE, 1/8" THICK
<u> </u>	SEGMENT TO SEGMENT	STEEL PLATE, 1/8" THICK
J	WINCH ASSEMBLY	
	WINCH	2" LASHING WINCH (10,000 LBS. STRENGTH)
14	STRAP	2" STRAP (10,000 LBS. STRENGTH)
K	WINCH PLATE	OTEGL DLATE A/ON THIOK
	HORIZONTAL	STEEL PLATE, 1/2" THICK
	THREADED STUDS	CFL FULLY THREADED STUD - 1/2"-13 x 1"




**NOTE:** THIS VIEW IS GENERIC TO ILLUSTRATE LOCATIONS OF ITEMS IN THE TABLE ONLY. CABLE PATTERN AND/OR OTHER DETAILS MAY NOT FULLY MATCH THE SPECIFICS FOR THIS ORDER. SEE OTHER SHEETS FOR ORDER-SPECIFIC DETAILS.

DEVELOPED BY
ClearSpan
A DIVISION OF ENGINEERING SERVICES & PRODUCTS CO. 1440 18TH AVENUE SW DYERSVILLE, IA 52040 P: 563.875.6113 F: 563.873.2317 WWW.ESAPCO.COM
ORDER #: <b>7888719</b>
CUSTOMER #:

1 11		STRUCTURE SKU #: TO56RKMF062060
CUSTOMER CONTACT:	CONTACT PHONE:	STRUCTURE SIZE: <b>56' X 60'</b>
SHEET TITLE: MATERIAL SPECIFICATIONS		STRUCTURE DESCRIPTION:

	DRAWING	DETAILS
DRA'	WN BY:	CREATION DATE 12/30/2024
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ANYSON OF ENGINEERING SERVICES & PRODUCTS CO.
1440 181H AVENUE SW
DYERSVILL 18, 25040
P. 583 478.5117
WWW.ESAPCO.COM

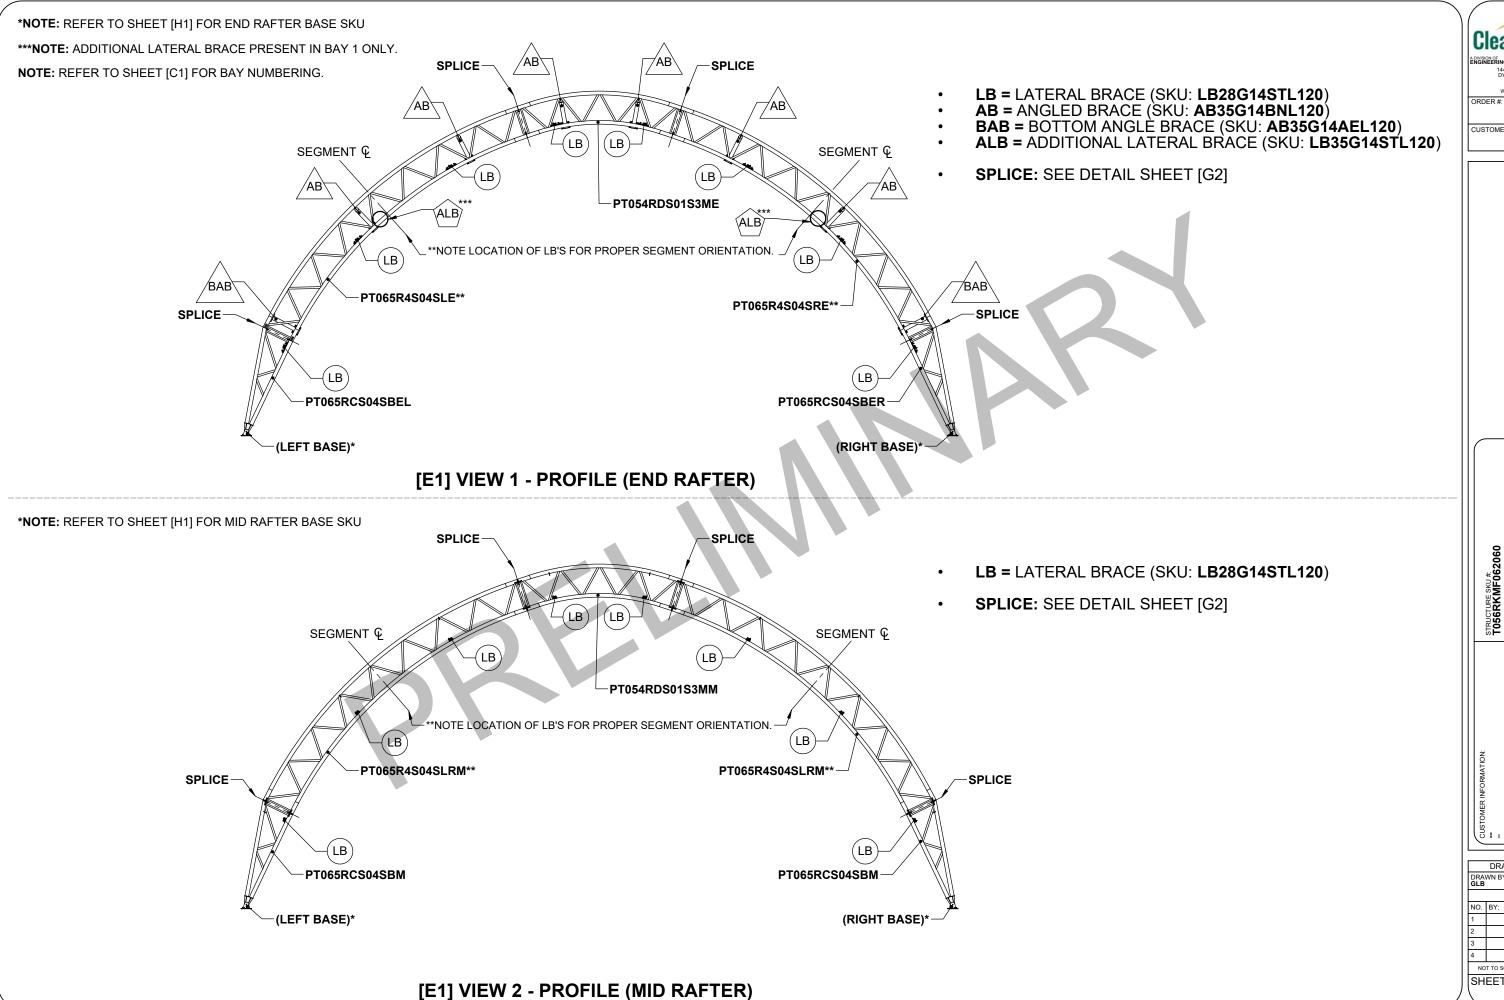ORDER #:
7888719

CUSTOMER #:

CUSTOMER INFORMATION:		STRUCTURE SKU # T056RKMF062060
CUSTOMER CONTACT:	CONTACT PHONE: STRUCTURE SIZE: 56' X 60'	STRUCTURE SIZE: <b>56' X 60'</b>
SHEET TITLE: RAFTER PROFILES		STRUCTURE DESCRIPTION:

	DRAWING	DETAILS
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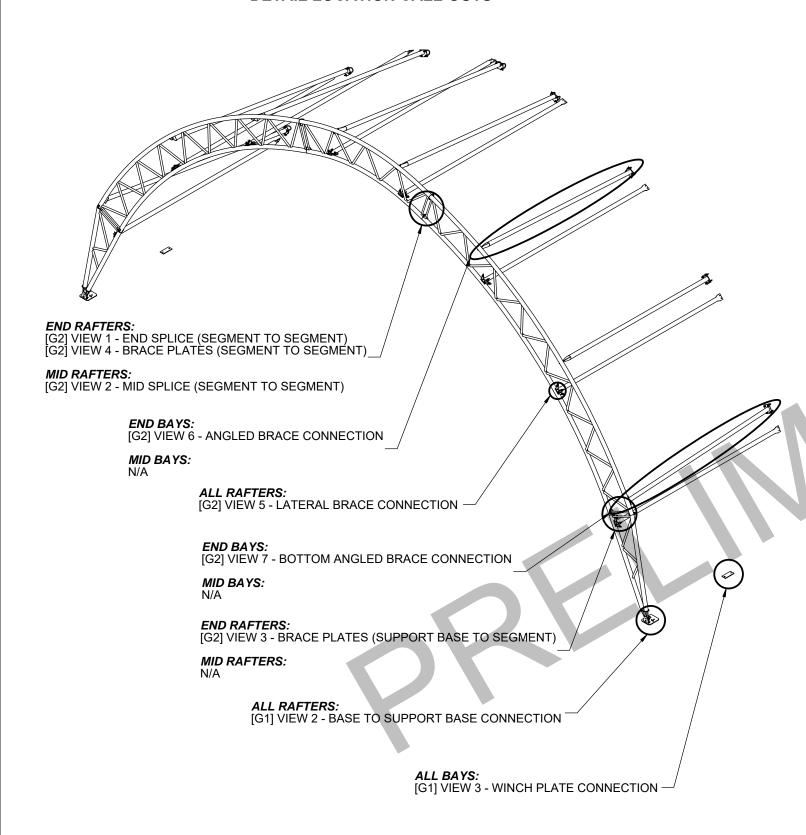


CUSTOMER #:

STRUCTURE SKU #. T056RKMF062060 STRUCTURE S **56' X 60'** 

REVISIONS: NOT TO SCALE SHEET SIZE: 11X17

#### **DETAIL LOCATION CALL-OUTS**



## DETAILS WITH LOCATION CALL-OUTS NOT SHOWN ON THIS SHEET:

[G2] VIEW 8 - ADDITIONAL LATERAL BRACE CONNECTION

G3] VIEW 1 - CABLE SKU PER SPAN


[G3] VIEW 2 - TYPICAL CABLE CONNECTION DETAIL

[G3] VIEW 3 - TYPICAL CABLE ASSEMBLY [G3] VIEW 4 - SWAY CABLE LOCATIONS


G31 VIEW 5 - SWAY CABLE DETAILS

G3 VIEW 6 - TYPICAL SWAY CABLE ASSEMBLY

# [G1] VIEW 1 - NOT USED

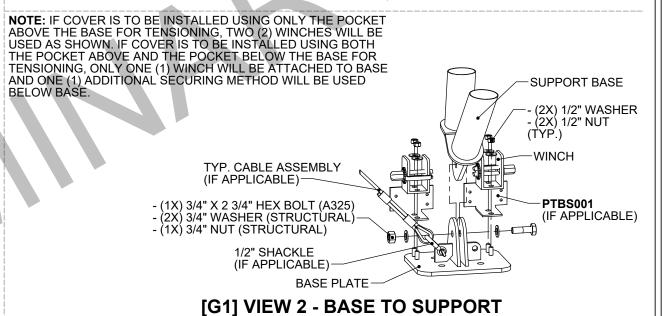

**BASE CONNECTION** 

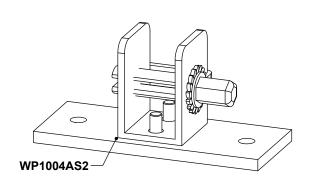

[G1] VIEW 3 - WINCH PLATE CONNECTION




CUSTOMER INFORMATION:		STRUCTURE SKU # TOSGRKMF062060
CUSTOMER CONTACT:	CONTACT PHONE:	CONTACT PHONE: STRUCTURE SIZE: 56' X 60'
SHEET TITLE: DETAIL LOCATIONS & BASE DETAILS	E DETAILS	STRUCTURE DESCRIPTION:

REVISIONS:


NOT TO SCALE SHEET SIZE: 11X17

G1

SHEET:

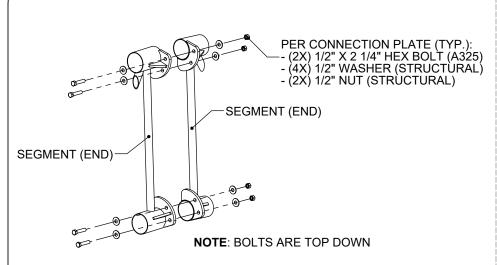

# [G2] VIEW 1 - END SPLICE (SEGMENT TO SEGMENT)

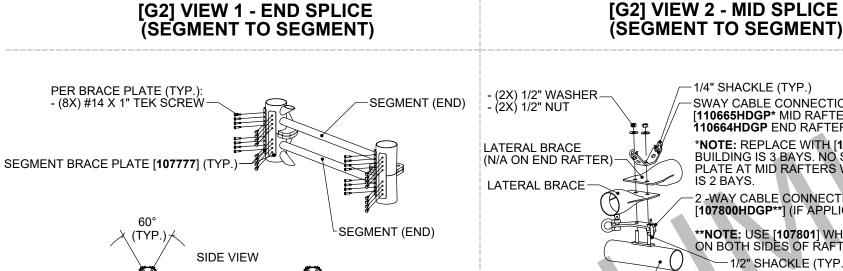


PER CONNECTION PLATE (TYP.): - (4X) 1/2" X 2 1/4" HEX BOLT (A325) - (8X) 1/2" WASHER (STRUCTURAL)

- (4X) 1/2" NUT (STRÙCTURAL)


PLATES SHOULD BE POSITIONED 30 DEGREES FROM CENTER OF FRONT OF CHORDS

## [G2] VIEW 4 - BRACE PLATES (SEGMENT TO SEGMENT)

(TYP.)

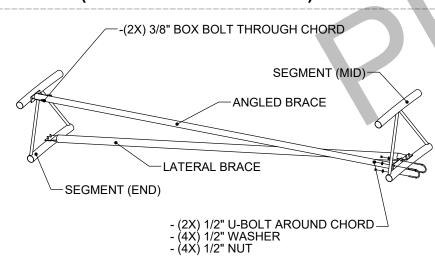

[G2] VIEW 7 - BOTTOM ANGLED BRACE CONNECTION

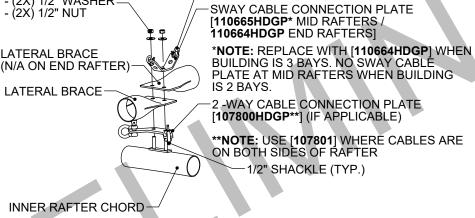


SEGMENT (MID)


NOTE: BOLTS ARE TOP DOWN

SEGMENT (MID)


## [G2] VIEW 5 - LATERAL BRACE CONNECTION

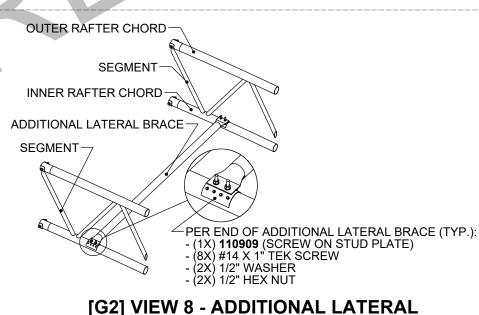


**BRACE CONNECTION** 

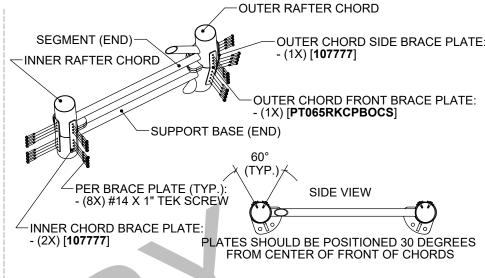

# [G2] VIEW 3 - BRACE PLATES (SUPPORT BASE TO SEGMENT)

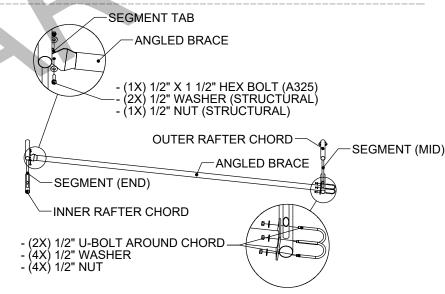

[G2] VIEW 6 - ANGLED BRACE CONNECTION

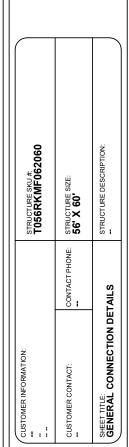

ClearSpan

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CUSTOMER #:

DRAWING DETAILS			
DRAWN BY: GLB		CREATION DATE: 12/30/2024	
REVISIONS:			
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SHEET:			

G2


#### NOTES:


- RAFTER VIEW SHOWN REPRESENTS TYPICAL CABLE SPAN LABELS TO ILLUSTRATE LOCATIONS OF SPANS IN THE TABLE. THE CABLE PATTERN SHOWN MAY NOT FULLY MATCH THE SPECIFICS FOR THIS
- CABLE PATTERN REPEATS ON OPPOSITE SIDE OF € UNLESS NOTED OTHERWISE.
- CABLE IS NOT PRESENT IN BAY NUMBERS NOT LISTED IN TABLE.

CABLE ATTACHMENT COMPONENTS			
TURNBUCKLE	1/2" X 12" GALV E-E		
SHACKLE	1/2" GALV		
CABLE	3/8" GALV 7X19		


#### \*REFER TO SHEET [C1] FOR BAY NUMBERING

BAY NUMBER* SPAN 'A' SPAN 'B' SPAN 'C'	SPAN 'D'	SPAN 'E'
1 & 6 CAB37G0901 CAB37G1008 CAB37G1000	CAB37G0908	CAB37G0808
2 & 5 CAB37G0901 CAB37G1008 N/A	N/A	N/A

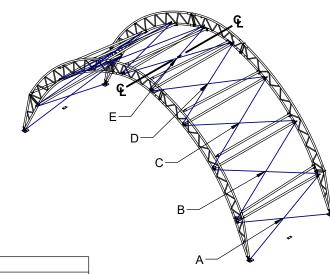

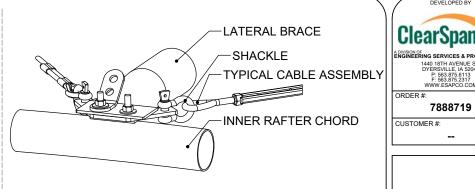

# [G3] VIEW 2 - TYPICAL CABLE CONNECTION DETAIL

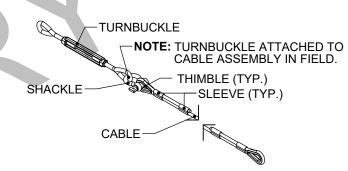


# [G3] VIEW 3 - TYPICAL CABLE ASSEMBLY

# TURNBUCKLE (JAW-JAW) NOTE: TURNBUCKLE ATTACHED TO CABLE ASSEMBLY IN FIELD. -SLEEVE (TYP.) THIMBLE (TYP.) **CABLE**

# [G3] VIEW 6 - TYPICAL SWAY CABLE ASSEMBLY

# [G3] VIEW 1 - CABLE SKU PER SPAN


#### SWAY CABLE REPEATS DOWN LENGTH OF BUILDING AT LOCATIONS SHOWN BELOW

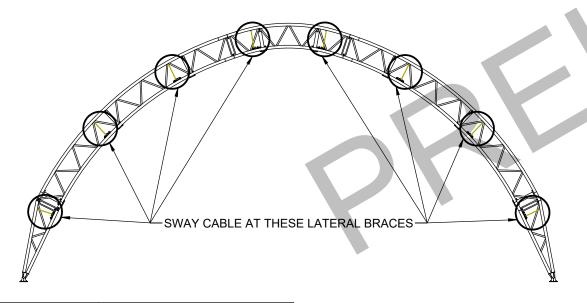


CABLE ATTACHMENT COMPONENTS		
TURNBUCKLE	1/2" X 6" GALV J-J	
SHACKLE	1/4" GALV	
CABLE	3/16" GALV 7X19	

\*REFER TO SHEET [C1] FOR BAY NUMBERING

SWAY CABLE ASSEMBLY SKU'S			
BAY NUMBER* SWAY CABLE SKU			
1 - 6	CAB18G0804		

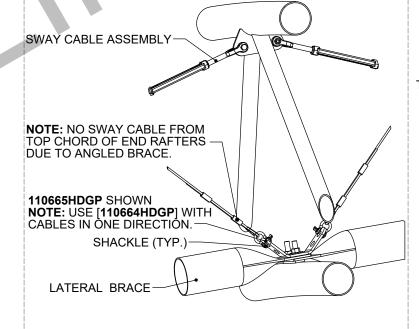

[G3] VIEW 5 - SWAY CABLE DETAILS

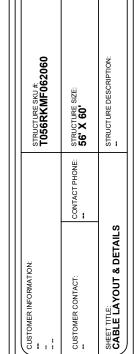


7888719

	DRAWING DETAILS			
DRA'	WN BY:	CREATION DATE: 12/30/2024		
	REVISIONS:			
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G3

[G3] VIEW 4 - SWAY CABLE LOCATIONS

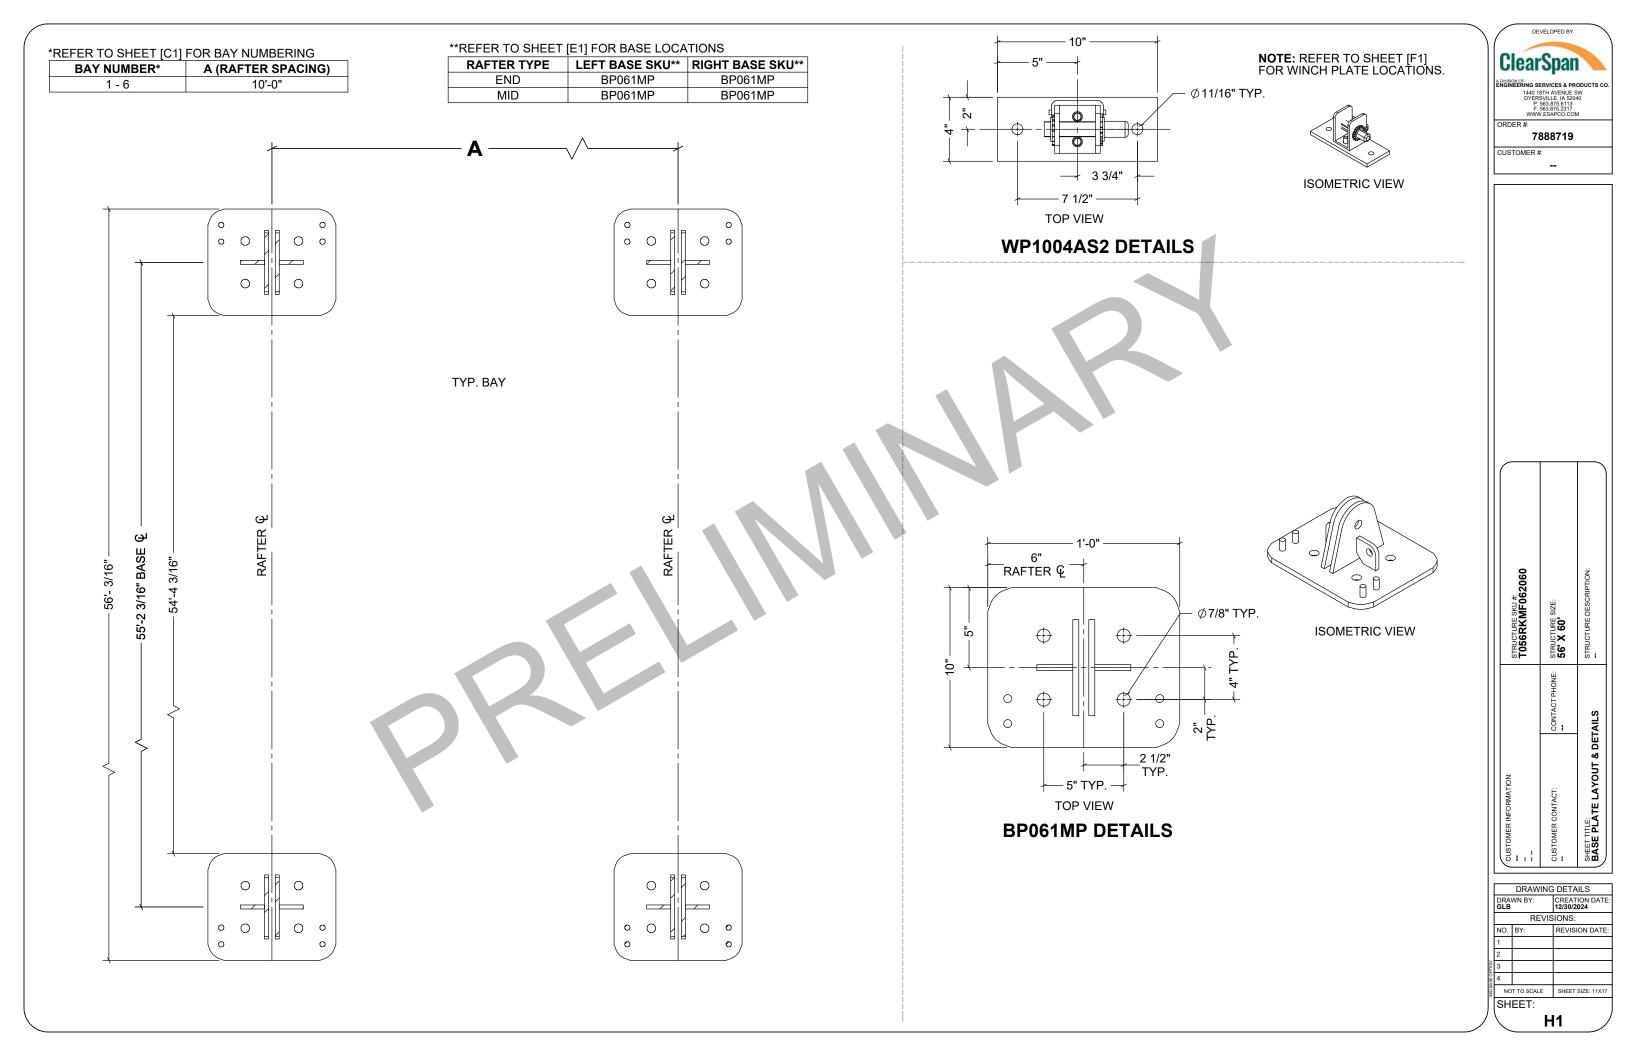

### **FOUNDATION NOTES:**

- CLEARSPAN DOES NOT PROVIDE ANY MATERIAL OR DESIGN CRITERIA FOR THE CREATION OF THE FOUNDATION OR ANCHORING OF THIS BUILDING, UNLESS OTHERWISE NOTED.
- FOUNDATION AND ANCHORING SHALL BE ENGINEERED AND APPROVED BY A LICENSED STRUCTURAL ENGINEER OF OWNER'S CHOICE.
- FOUNDATION MUST MEET THE BUILDING REACTION DATA SHOWN BELOW.
- SEE ENDWALL DRAWINGS FOR ENDWALL REACTIONS (IF APPLICABLE).





STRUCTURE SKU # T056RKMF062060	SIZE:	STRUCTURE DESCRIPTION:
STRUCTURE STRUCTURE	STRUCTURE 56' X 60'	STRUCTURE
	CONTACT PHONE: STRUCTURE SIZE: 56' X 60'	
CUSTOMER INFORMATION:	CUSTOMER CONTACT:	SHEET TITLE: BUILDING REACTION DATA

ΙГ	DRAWING DETAILS		
	DRAWN BY: GLB		CREATION DATE: 12/30/2024
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ΙF	NO.	BY:	REVISION DATE:
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