

Eschberger - DNR, Amy <amy.eschberger@state.co.us>

Lyons Quarry M-1977-141 Technical Revision 4 Addendum

Snyder, Travis < Travis. Snyder@hdrinc.com>

Wed, Feb 9, 2022 at 4:33 PM

To: "Eschberger - DNR, Amy" <amy.eschberger@state.co.us> Cc: Wyatt Webster <wyatt.webster@lafargeholcim.com>

Hello Amy,

Please see the attached request for addendum to M-1977-141 Technical Revision 4 regarding revisions to the floodplain reclamation plan and drawings. Additional documents included with this request include:

- Lyons Quarry Reclamation Plan Drawings Revision 3 (dated 2/4/2022)
- Engineer stamped letter to Boulder County Floodplain Manager, Virginia Gazzetti, confirming the hydraulic modeling developed for the FDP application is still valid
- Approval from BCPOS (dated 2/9/2022) for revisions made to the floodplain reclamation plan and drawings

Let us know if you have any questions. Thank you.

Travis Snyder


Project Manager

HDR

369 Inverness Parkway, Suite 325 Englewood, CO 80112 M 720.838.6065 D 303.643.6715 Travis.Snyder@hdrinc.com

hdrinc.com/follow-us

4 attachments

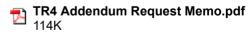

220209 BCPOS Approval for Revisions to Floodplain Design.pdf 256K

220202 Lyons Quarry Floodplain Design Update.pdf 117K

Lyons Quarry Rev 3 _Updated_2-4-22_reduced.pdf 20052K

Memo

Date:	Wednesday, February 09, 2022
Project:	Lyons Quarry Reclamation – Phase II Floodplain
To:	Amy Eschberger, DRMS Environmental Protection Specialist
From:	Travis Snyder, HDR Project Manager

Subject: Addendum to Technical Revision 4 for Permit M-1977-141 Lyons Quarry Reclamation Plan

Dear Ms. Eschberger,

The following represents documentation for revisions to the Lyons Quarry Reclamation Plan detailed under Technical Revision 4 of permit M-1977-141 based on discussions held in January 2022 with Boulder County Parks and Open Space (BCPOS) in obtaining a Floodplain Development Permit (FDP) for the work covered under Technical Revision 4 (approved by DRMS December 14, 2020). Boulder County has requested minor modifications to the proposed reclamation plan for the floodplain as they plan for their own restoration of South St. Vrain Creek following the 2013 flood event. Aggregate Industries proposes the following changes to the project design plans as shown in the accompanying drawing package.

- Sheet C-02
 - Removed the floodplain fill quantity and updated total. The previous floodplain cut quantity did not include the over excavation for the soil riprap.
- Sheet C-05
 - Updated detail number callouts
- Sheet C-06
 - Added proposed scour toe profile based on the Boulder County South St. Vrain 30% design concept grades and minor detail revision. The new profile will result in additional cut along the scour berm. Scour berm now to be constructed using soil riprap with material sourced onsite.
- Sheet C-08
 - Removed coir matting detail and added the scour berm foundation detail
- Sheet C-09
 - Revised hatching and updated area table

Aggregate requests the following documents be added to the M-1977-141 permit file for Technical Revision 4:

- Lyons Quarry Reclamation Plan Drawings Revision 3 (dated 2/4/2022)
- Engineer stamped letter to Boulder County Floodplain Manager, Virginia Gazzetti, confirming the hydraulic modeling developed for the FDP application is still valid
- Approval from BCPOS (dated 2/9/2022) for revisions made to the floodplain reclamation plan and drawings

If you have any questions comments or require additional information, please contact me at 720.838.6065 (C) or email me at travis.snyder@hdrinc.com.

Snyder, Travis

From: Atherton-Wood, Justin <jatherton-wood@bouldercounty.org>

Sent: Wednesday, February 9, 2022 4:11 PM

To: Snyder, Travis; McAnally, Jonathan; Strenge, Ernst; Wyatt Webster

Cc: Kc, Prashant; Hirt, David; Spaulding, Susan; Wheeler, Brent

Subject: RE: Lyons Quarry - Floodplain Reclamation Plan

CAUTION: [EXTERNAL] This email originated from outside of the organization. Do not click links or open attachments unless you recognize the sender and know the content is safe.

Hi Travis-

I'm responding on behalf Parks & Open Space. We very much appreciate HDR and Aggregate incorporating our comments and concerns into the revised drawings! The revisions look great to us. I will also let Virginia know that BCPOS supports approval of the floodplain development permit.

When it comes time to implementing the section of the scour berm with the boulder toe, we request that our engineer (Prashant) be included in observing field conditions. Based on observed conditions, we may request just a bit more depth to the toe using onsite material than is shown in the detail just to ensure a connection with the shallow bedrock. Our desire is to create long term stability of the berm and the planned creek alignment in the area where the planned alignment comes closest to the berm (i.e., in the vicinity of STA 109+00). Would you all be amenable to that?

We really appreciate your commitment to supporting the long term vision for this open space property. And, we sincerely appreciate your on-going communication and collaboration!

Thanks, Justin

Justin Atherton-Wood | Senior Planner

Boulder County Parks and Open Space 5201 St. Vrain Road, Longmont, CO 80503 (o) 303-678-6273 | (f) 303-678-6179 jatherton-wood@bouldercounty.org www.BoulderCountyOpenSpace.org

CELL NO. 720-601-9511

From: Snyder, Travis <Travis.Snyder@hdrinc.com>

Sent: Monday, February 07, 2022 4:27 PM

To: McAnally, Jonathan <Jonathan.McAnally@hdrinc.com>; Strenge, Ernst <estrenge@bouldercounty.org>; Wyatt Webster <wyatt.webster@lafargeholcim.com>

Cc: Atherton-Wood, Justin <jatherton-wood@bouldercounty.org>; Kc, Prashant <pkc@bouldercounty.org>; Hirt, David

<dhirt@bouldercounty.org>; Spaulding, Susan <sspaulding@bouldercounty.org>; Wheeler, Brent

<bwheeler@bouldercounty.org>

Subject: [EXTERNAL] RE: Lyons Quarry - Floodplain Reclamation Plan

Hi all,

Please review the attached revisions to the Lyons Quarry floodplain design based on our January 18, 2022 conversation. Revisions to the plan set include:

- C-02 Removed the floodplain fill quantity and updated total. The previous floodplain cut quantity we had did not include the over excavation for the soil riprap so that value was unchanged.
- C-05 Updated detail number callouts
- C-06 Added proposed scour toe profile based on Matrix 30% grades and minor detail revision. The new profile will result in additional cut along the scour berm.
- C-08 Removed coir matting detail and added the scour berm foundation detail
- C-09 Revised hatching and updated area table

Please let us know if you have any comments before we submit these changes to Virginia Gazzetti at the floodplain office to finalize the floodplain development permit.

Travis Snyder

M 720.838.6065 D 303.643.6715

hdrinc.com/follow-us

From: McAnally, Jonathan < <u>Jonathan.McAnally@hdrinc.com</u>>

Sent: Monday, January 17, 2022 3:09 PM

To: Snyder, Travis < Travis < Travis < Travis.Snyder@hdrinc.com; Strenge, Ernst < estrenge@bouldercounty.org; Wyatt Webster wyatt.webster@lafargeholcim.com; Strenge, Ernst < estrenge@bouldercounty.org; Wyatt Webster wyatt.webster@lafargeholcim.com;

Cc: Atherton-Wood, Justin <<u>jatherton-wood@bouldercounty.org</u>>; Kc, Prashant <<u>pkc@bouldercounty.org</u>>; Hirt, David <<u>dhirt@bouldercounty.org</u>>; Spaulding, Susan <<u>sspaulding@bouldercounty.org</u>>; Wheeler, Brent <<u>bwheeler@bouldercounty.org</u>>

Subject: RE: Lyons Quarry - Floodplain Reclamation Plan

All, I have attached cross sections comparing the existing grade, the proposed quarry reclamation grade, and the 30% stream restoration grade along with the floodplain workmap (page 6) for reference.

The proposed reclamation grade within the floodplain is approximate and based on the anticipated amount of material to be removed and the standard section for the scour berm but is generally at or above the 30% design grade.

The closest the scour berm gets to the proposed channel is ~30 feet from the right bank. The berm was designed to be self-launching meaning it would back fill any scour that may occur. This was done to allow riprap to be placed at existing grade. Rock was sized to the 100-yr event and the volume of rock is based on the potential depth of scour with a 150% multiplier to provide a factor of safety. We can discuss the need for additional armoring at the pinch point tomorrow.

Thanks,

Jon McAnally, PE, CFM **D** 303.524.8362

hdrinc.com/follow-us

From: Snyder, Travis < Travis. Snyder@hdrinc.com>

Sent: Monday, January 17, 2022 11:32 AM

To: Strenge, Ernst <<u>estrenge@bouldercounty.org</u>>; Wyatt Webster <<u>wyatt.webster@lafargeholcim.com</u>>; McAnally, Jonathan <<u>Jonathan.McAnally@hdrinc.com</u>>

Cc: Atherton-Wood, Justin <<u>jatherton-wood@bouldercounty.org</u>>; Kc, Prashant <<u>pkc@bouldercounty.org</u>>; Hirt, David <<u>dhirt@bouldercounty.org</u>>; Spaulding, Susan <<u>sspaulding@bouldercounty.org</u>>; Wheeler, Brent



Virginia,

HDR met with Prashant, Ernst, and a few others from Parks and Open Space on Tuesday January 18th regarding comments they had on the design. Based on our discussion we have incorporated the following minor edits to the plans:

- Revised specifications to use existing alluvium material as fill instead of importing riprap. Type L angular riprap will still be used along streambanks.
- Detailed use of largest boulders (3-4' diameter) to be installed approximately Sta. 109+00 of the scour berm to provide a step foundation.
- Revised scour berm to include soil mix for filling gaps and to allow for topsoil placement over scour berm
- Revised the total amount of excavation volume assuming no over-excavation is needed now that alluvium is replacing riprap as fill
 - This may or may not be offset by the presence of organic material that may be available below the crusher fines. If available, the topsoil will be reclaimed/stockpiled for future use.

Let this letter serve as verification that the hydraulic modeling developed in support of our Floodplain Development Permit Application submitted on December 2nd, 2021, is still valid since these updates will not change the proposed grades within the floodplain and the soil riprap previously specified was assumed to have the same roughness as the existing alluvium which will now be utilized.

Please

Sincerely,

Jonathan McAnally, P.E., CFM



AGGREGATE INDUSTRIES

LYONS QUARRY RECLAMATION PROJECT



PROJECT VICINITY

SCALE: NTS

INDEX OF DRAWINGS

GENERAL 00G-01 00G-02 00G-03	COVER & DRAWING INDEX GENERAL NOTES & LEGEND PLAN OF EXISTING CONDITIONS & SURVEY CONTROL
CIVIL	
01C-01	SITE ACCESS & STAGING AREAS
01C-02	FLOODPLAIN SOIL REMOVAL AND SITE GRADING PLAN
01C-03	FINAL GRADING PROFILE, SECTION, & DETAILS
01C-04	ROCK REINFORCEMENT DETAILS
01C-05	DRAINAGE & EROSION CONTROL PLAN
01C-06	SCOUR BERM SECTION & DETAILS
01C-07	DRAINAGE & EROSION CONTROL DETAILS
01C-08	DRAINAGE & EROSION CONTROL DETAILS
01C-09	OVERALL RECLAMATION PLAN & DETAILS




AGGREGATE INDUSTRIES
LYONS QUARRY
RECLAMATION PROJECT

GENERAL COVER & DRAWING INDEX


FILENAME 00G-01.dwg

SCALE AS NOTED

00G-01

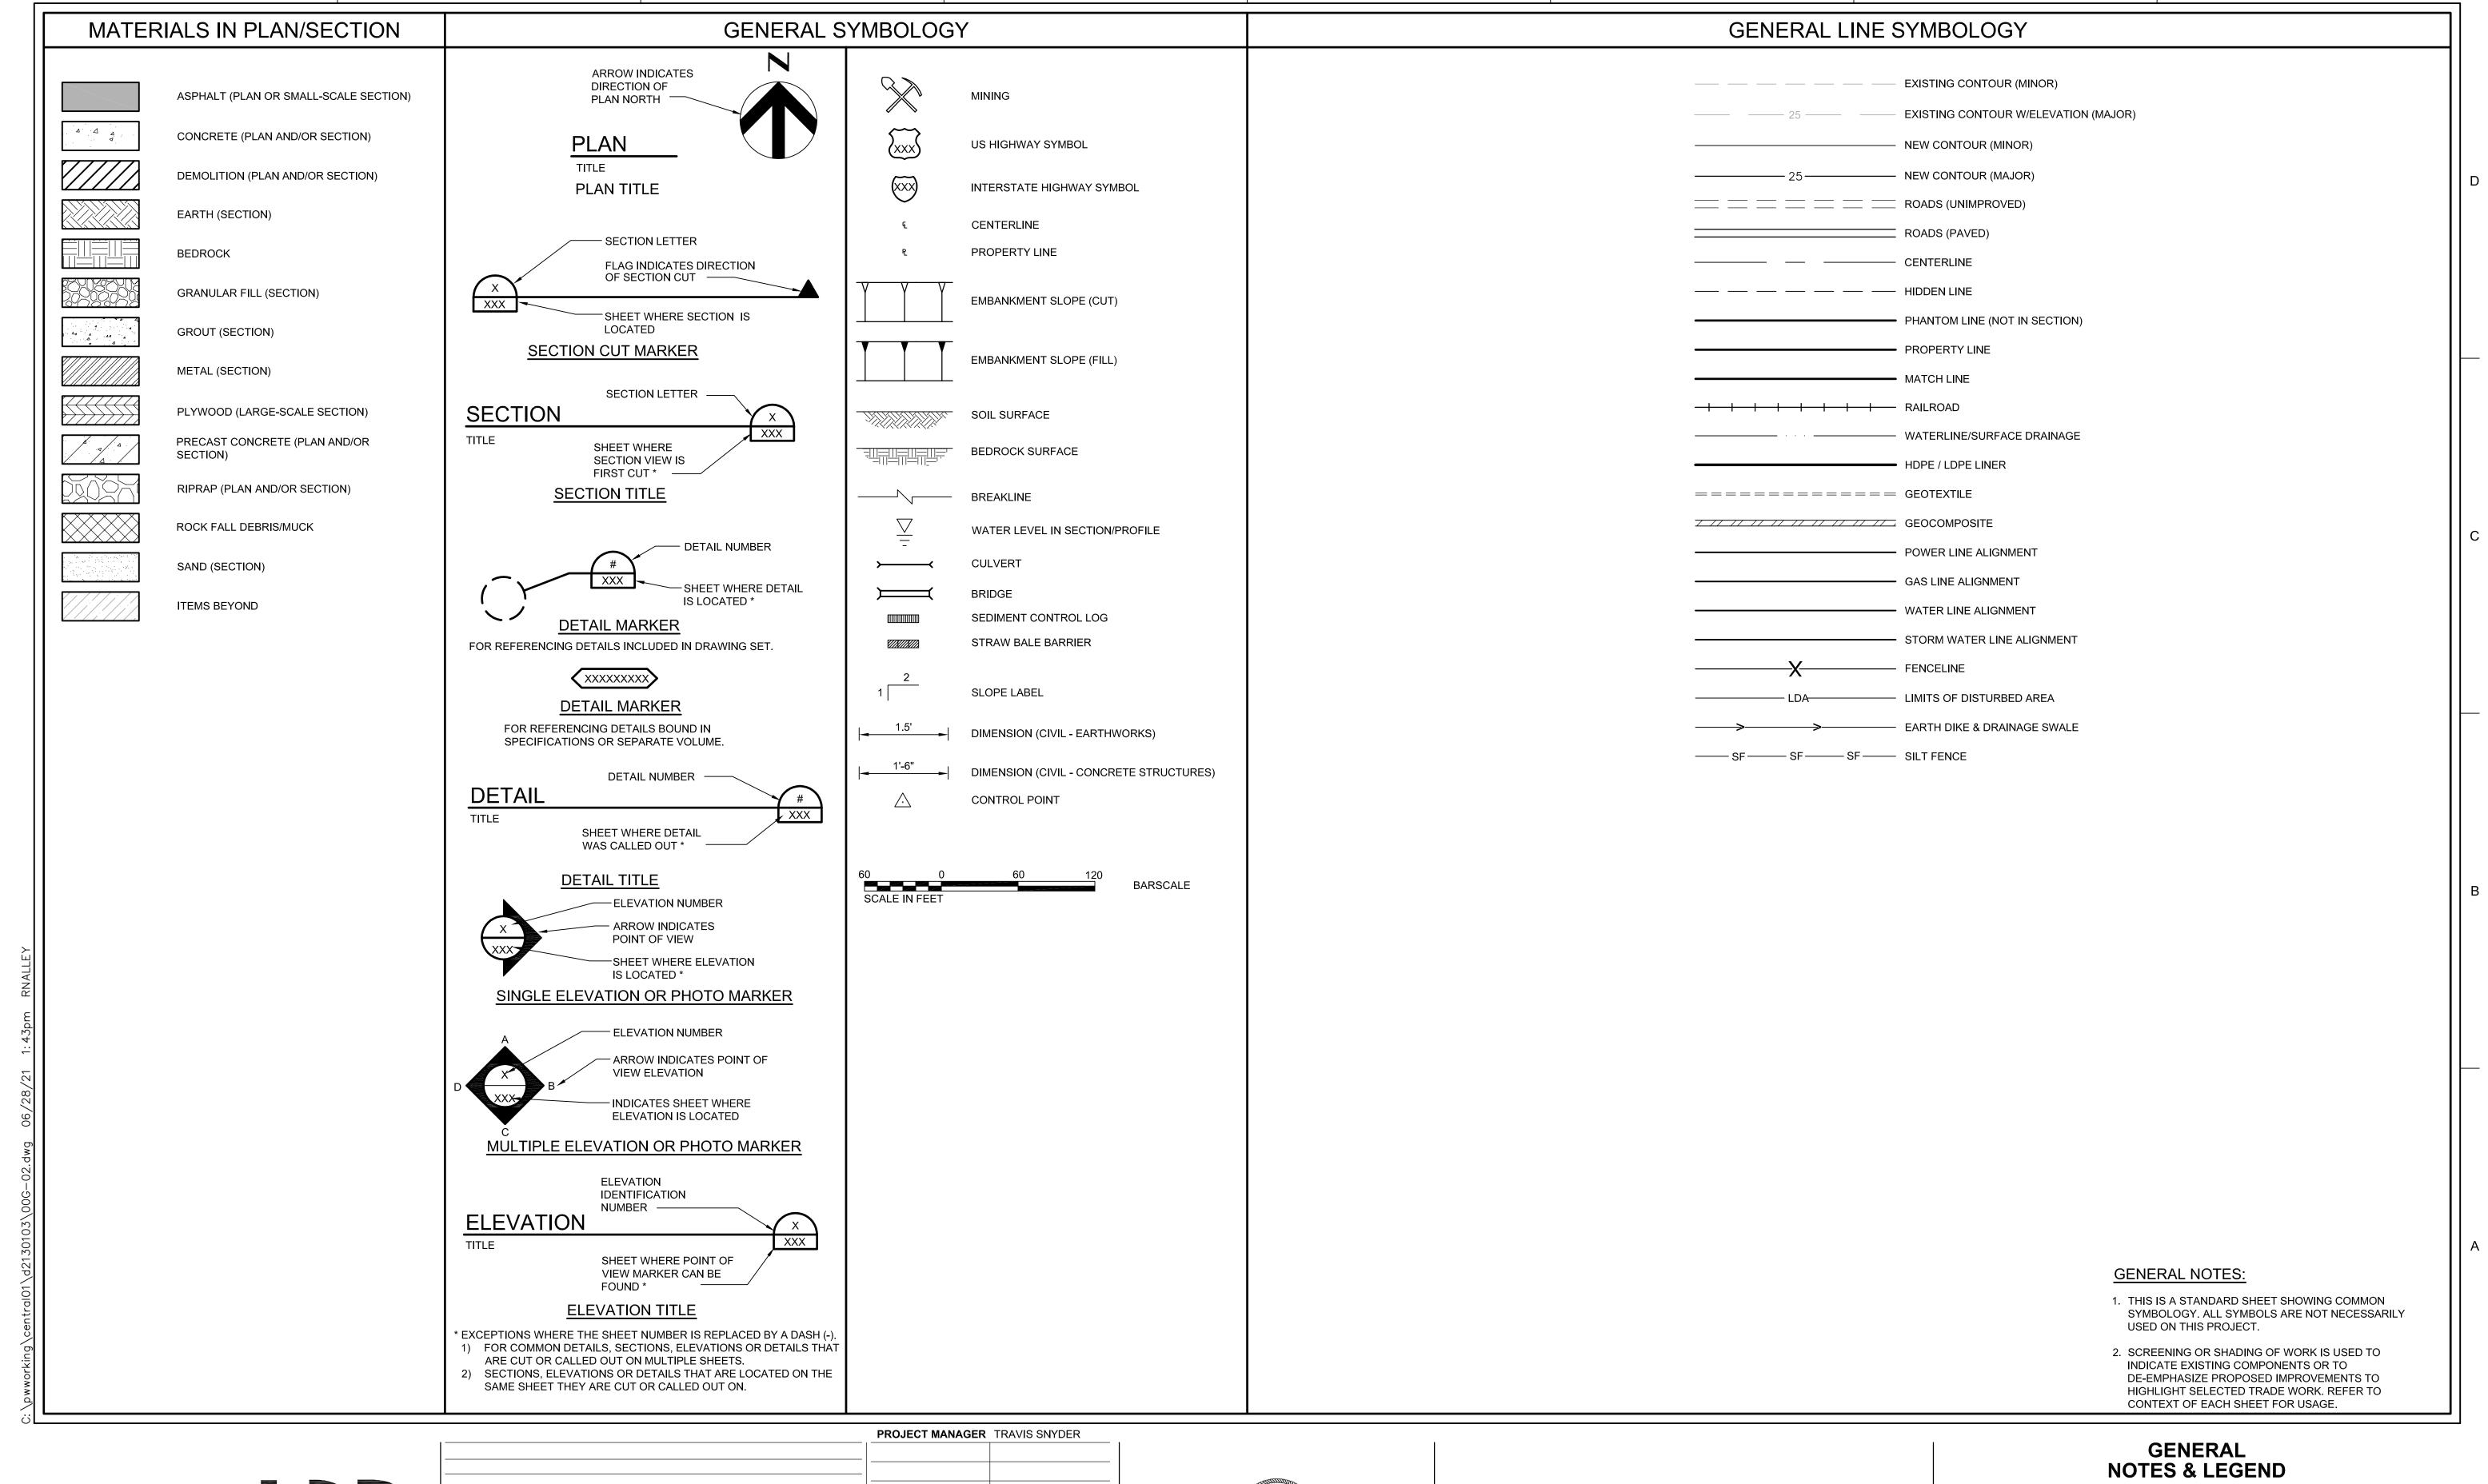



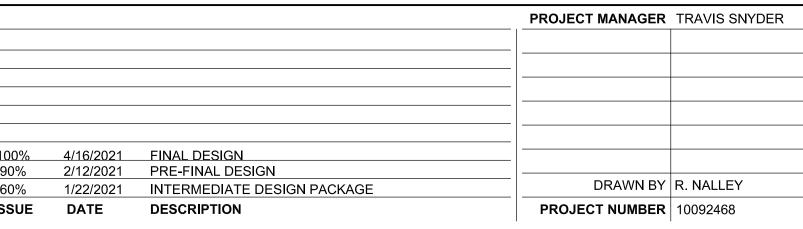





AGGREGATE INDUSTRIES
LYONS QUARRY
RECLAMATION PROJECT


FILENAME 00G-02.dwg


SCALE AS NOTED

00G-02

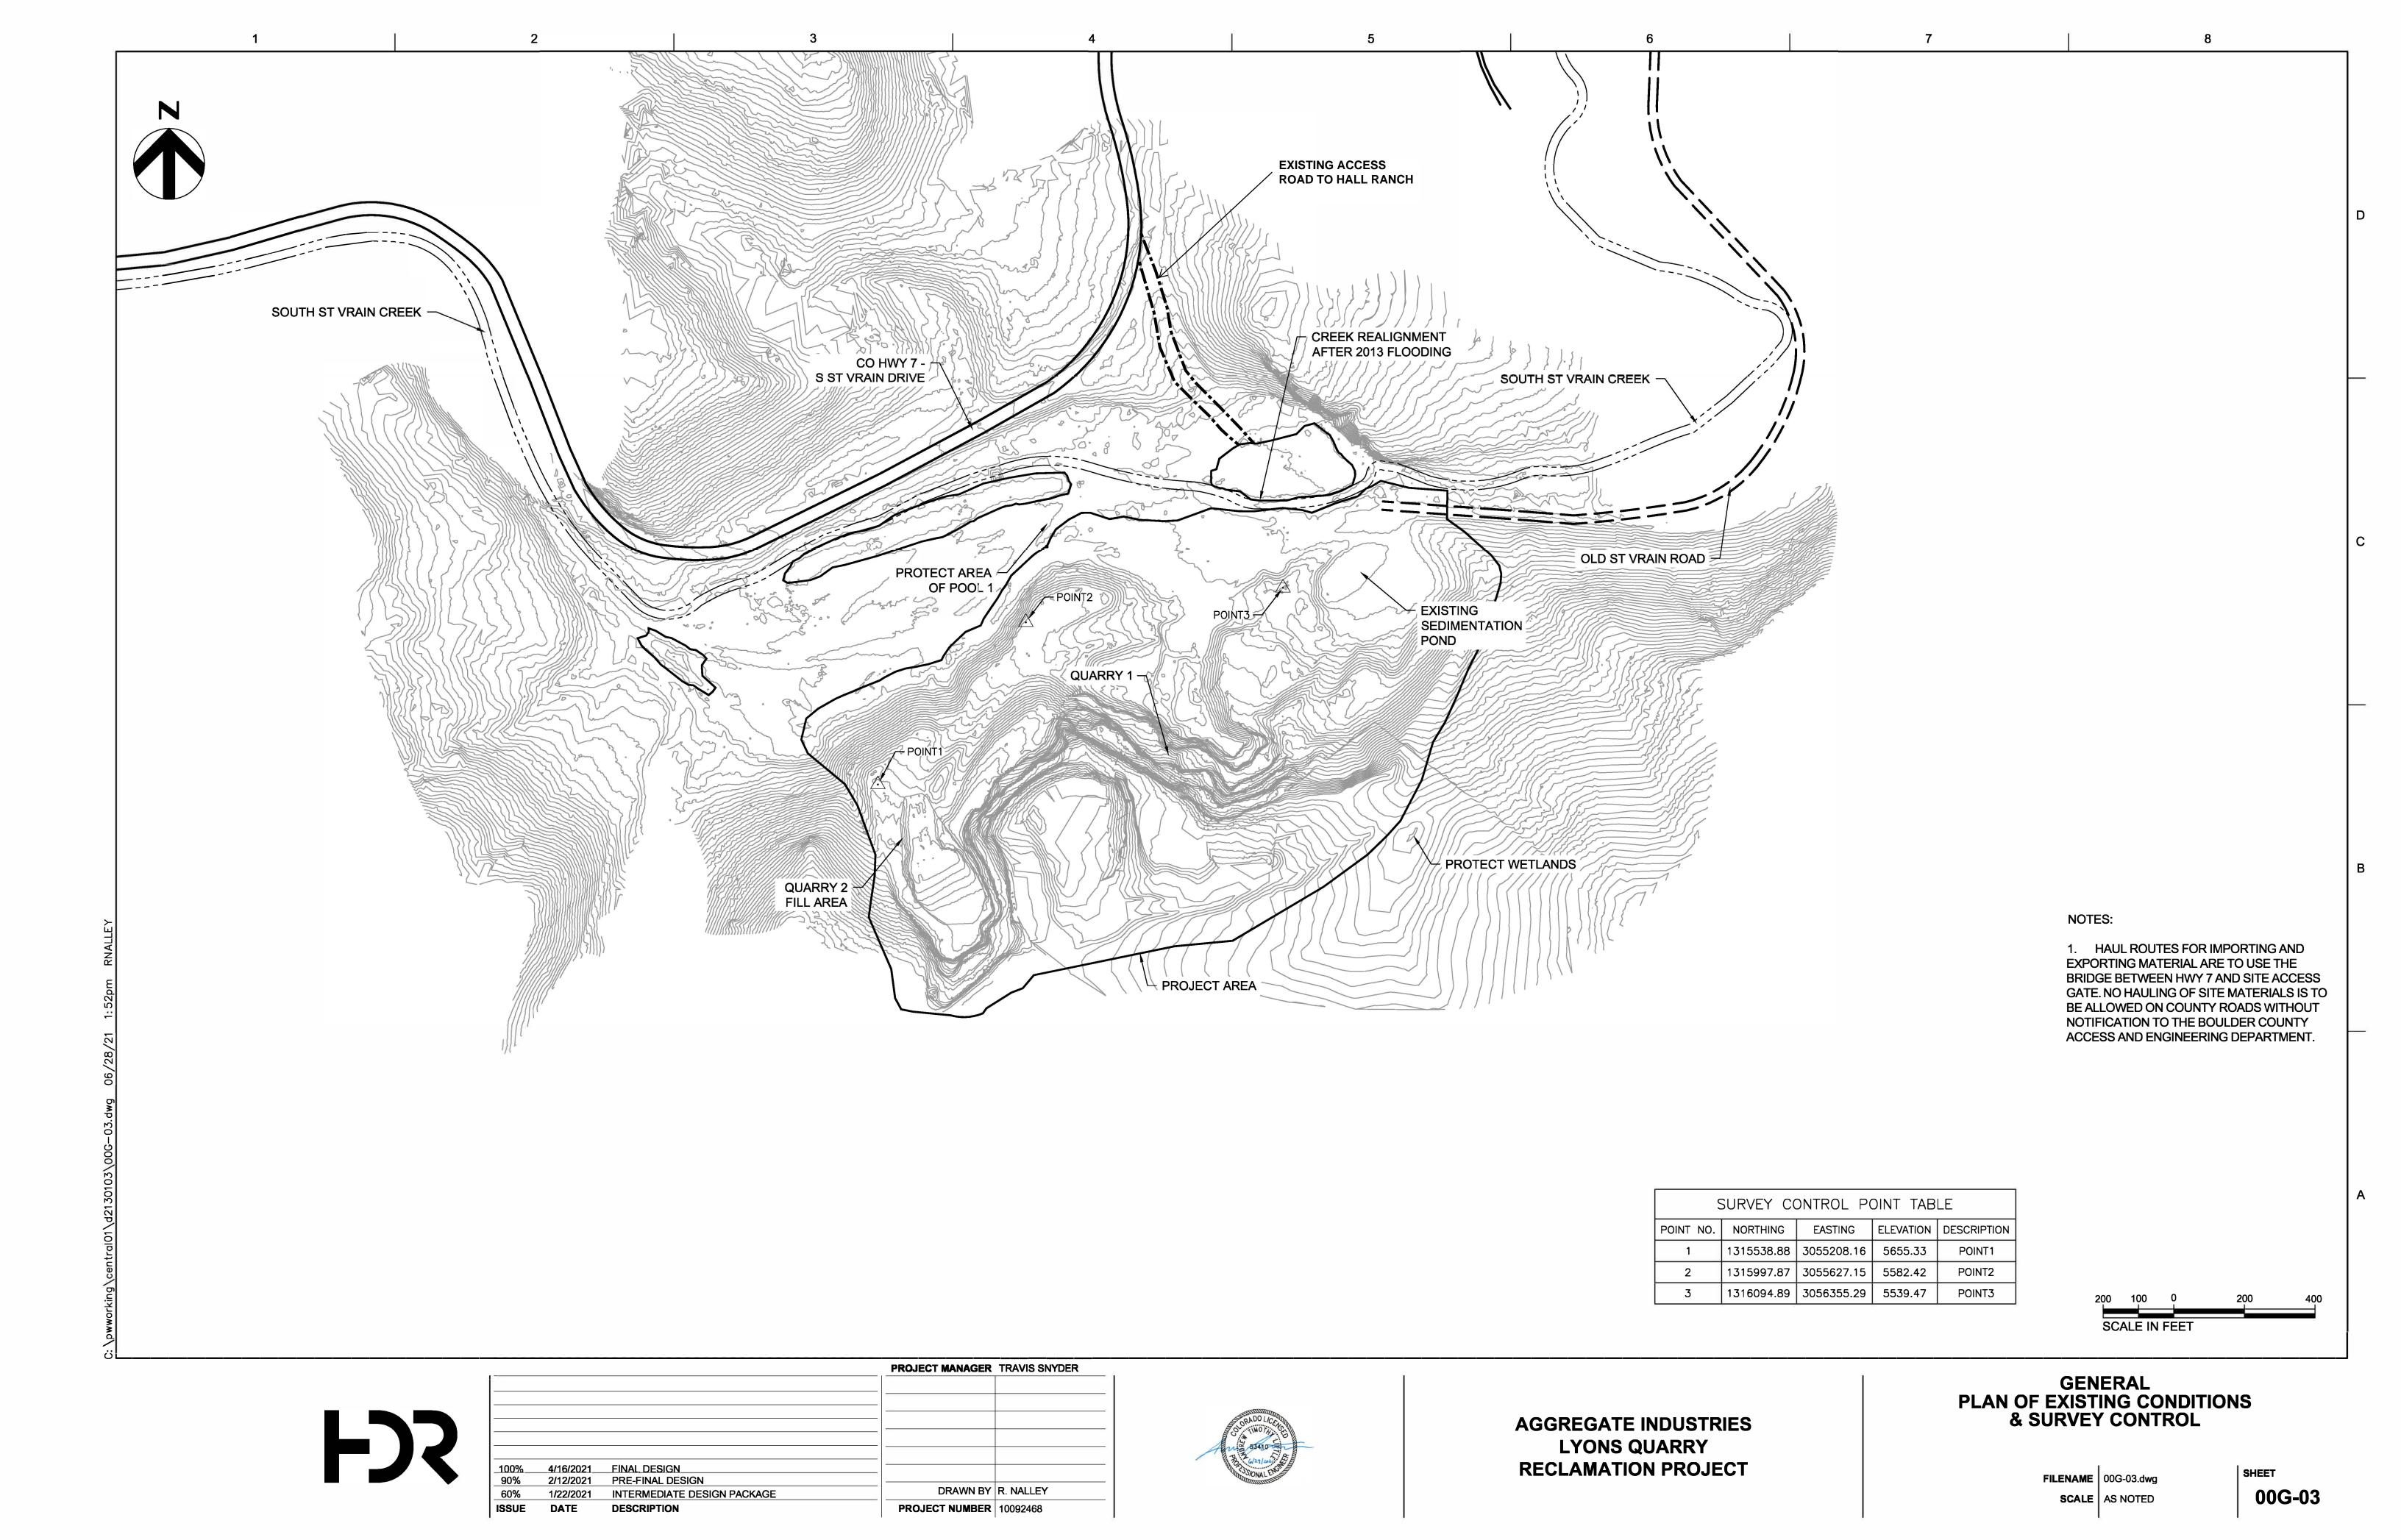

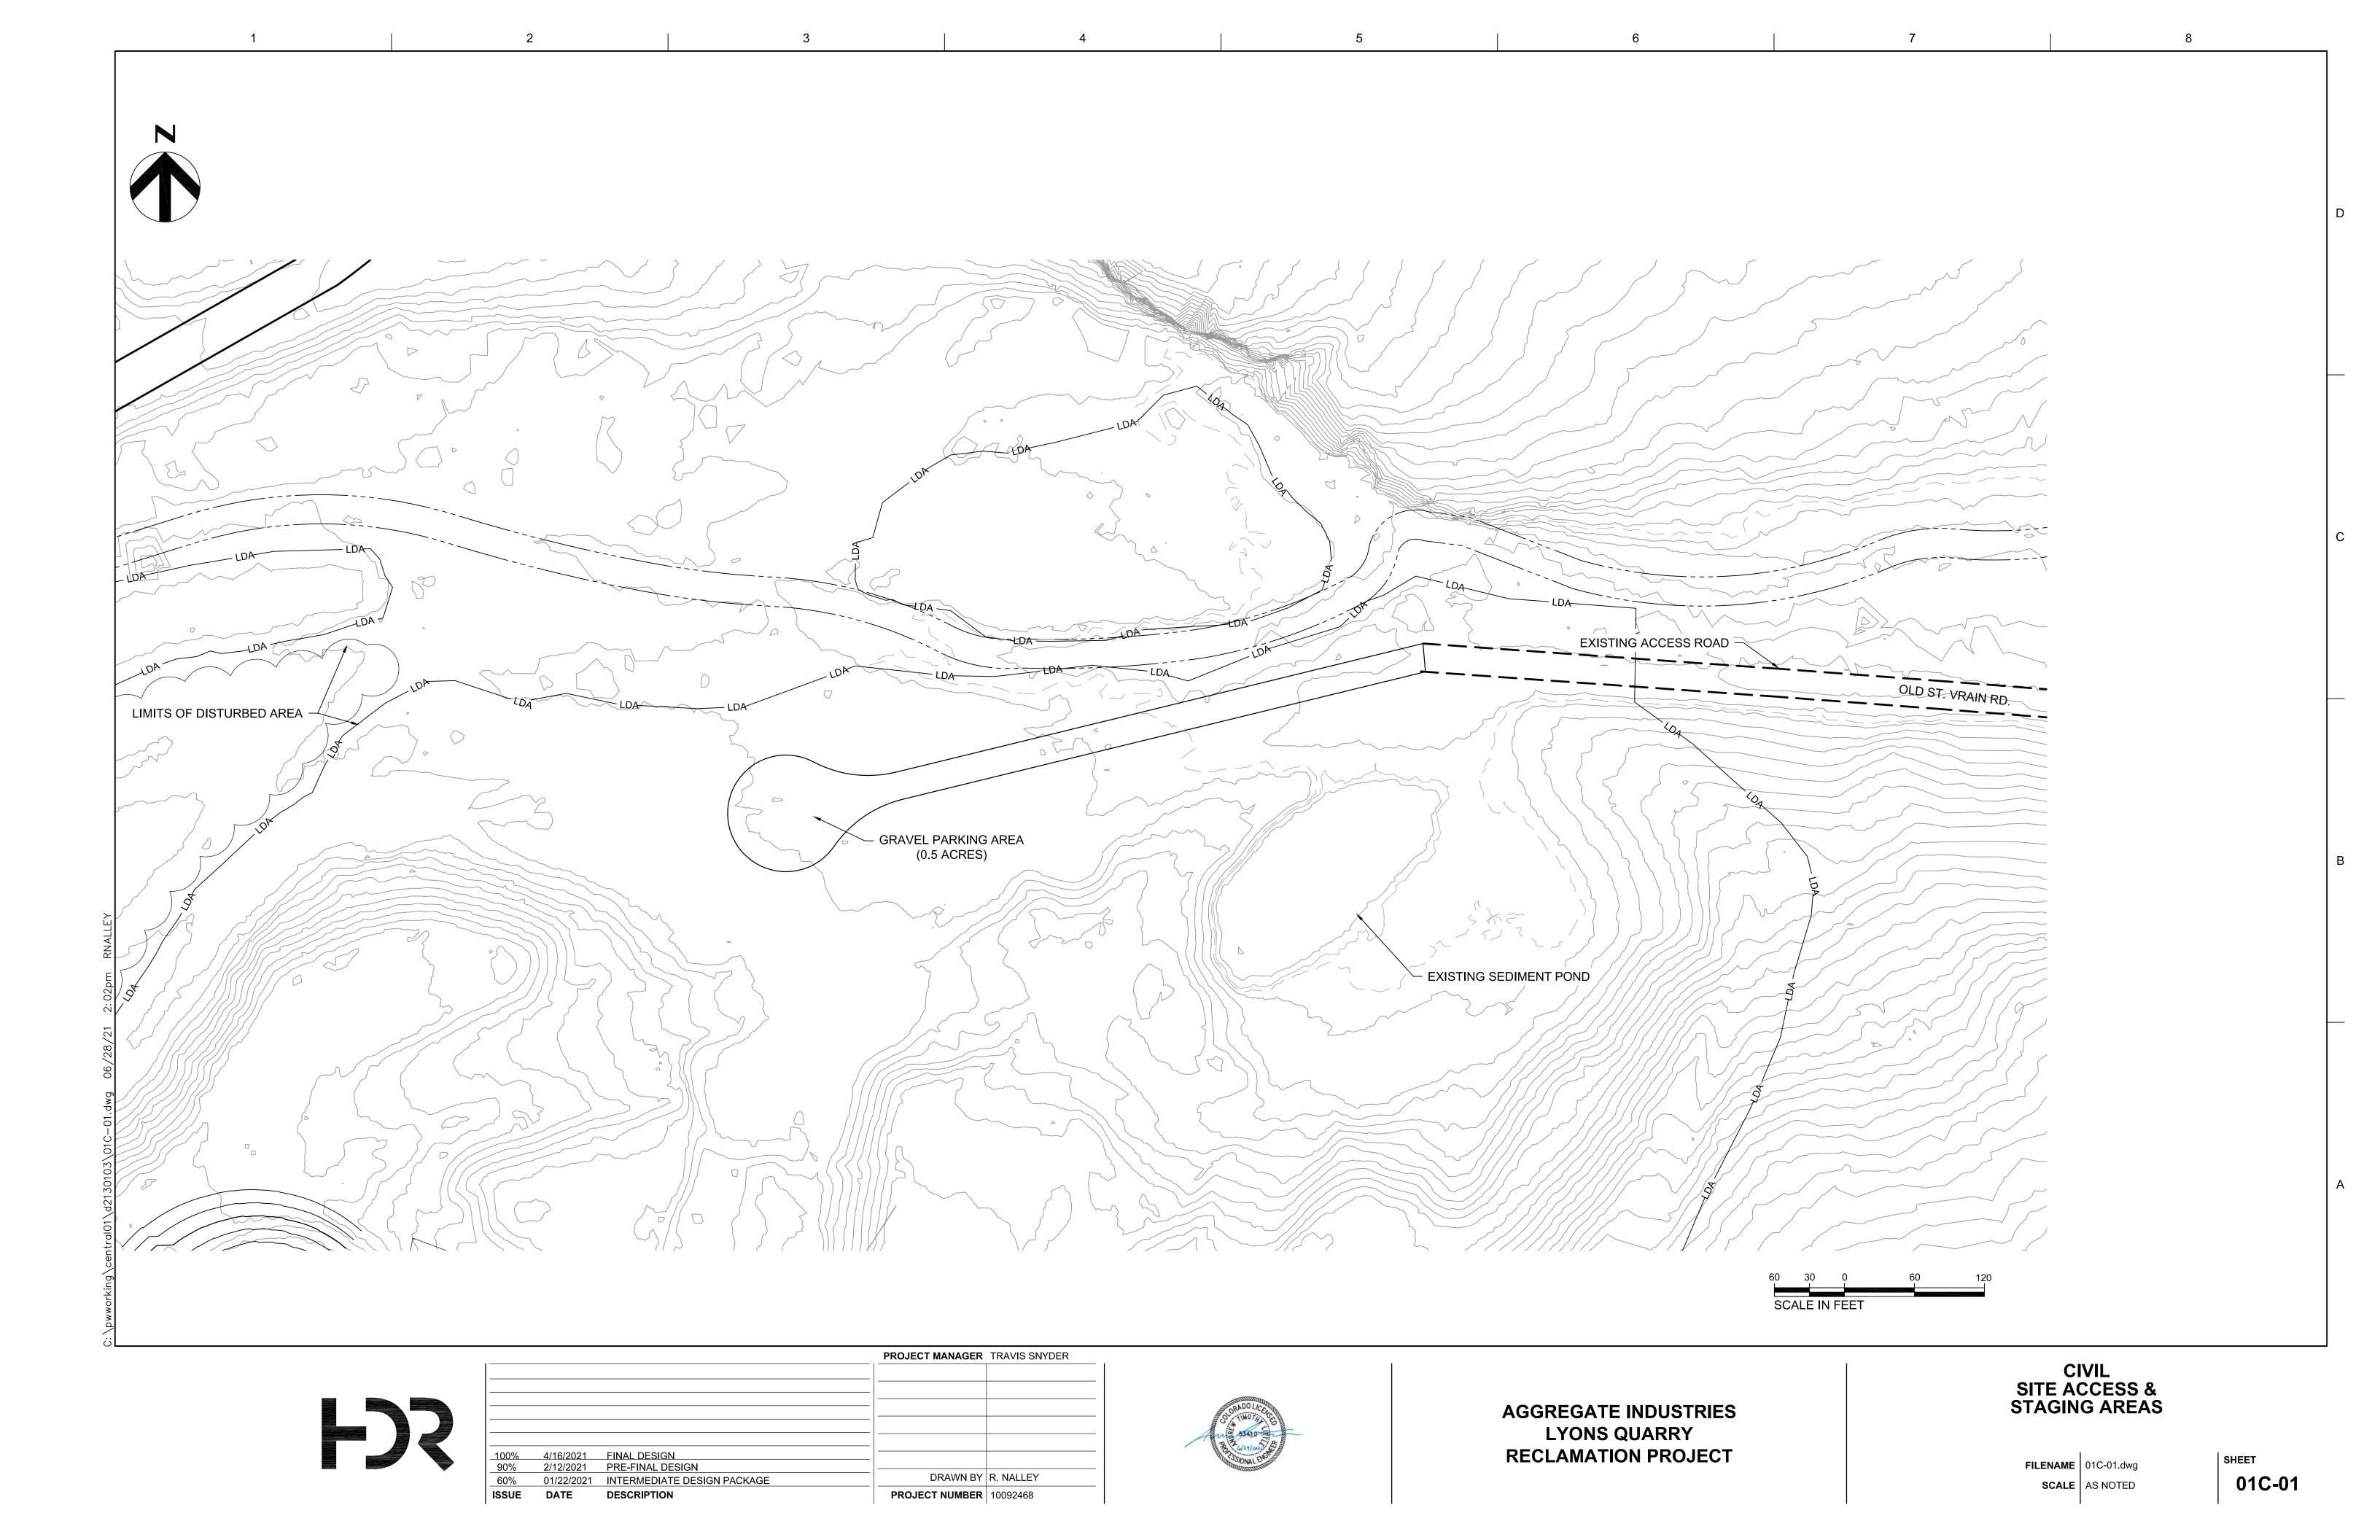


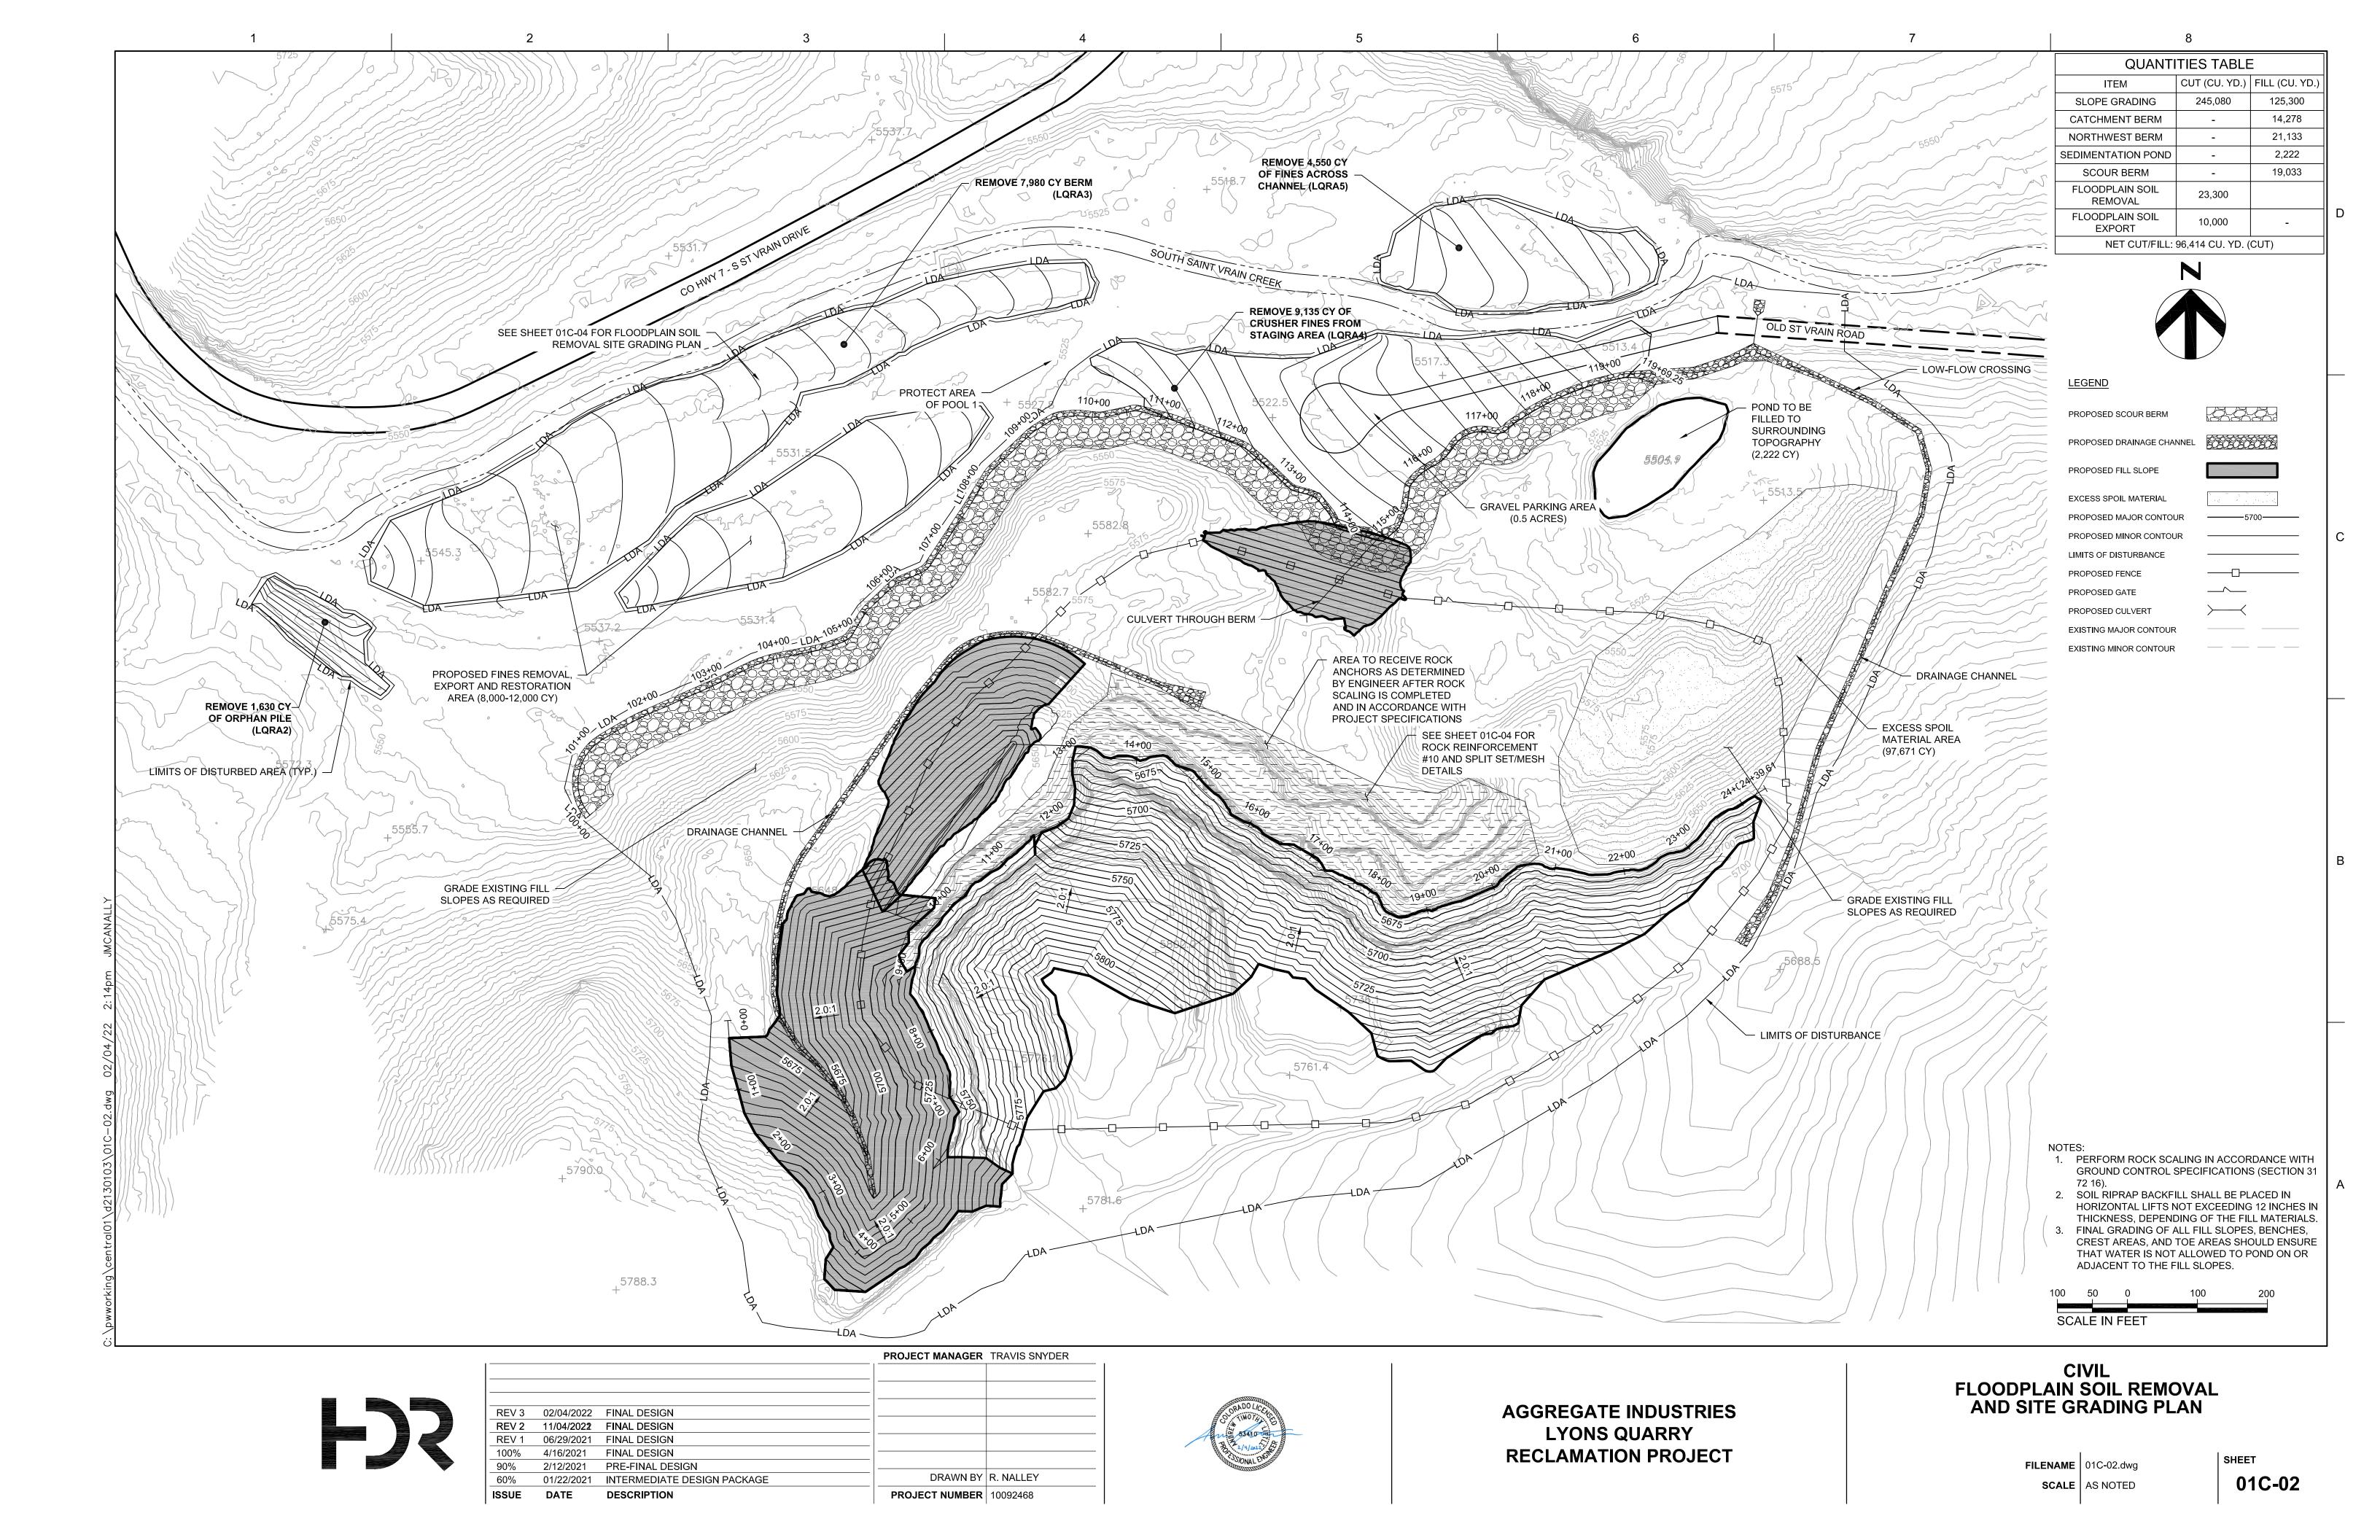

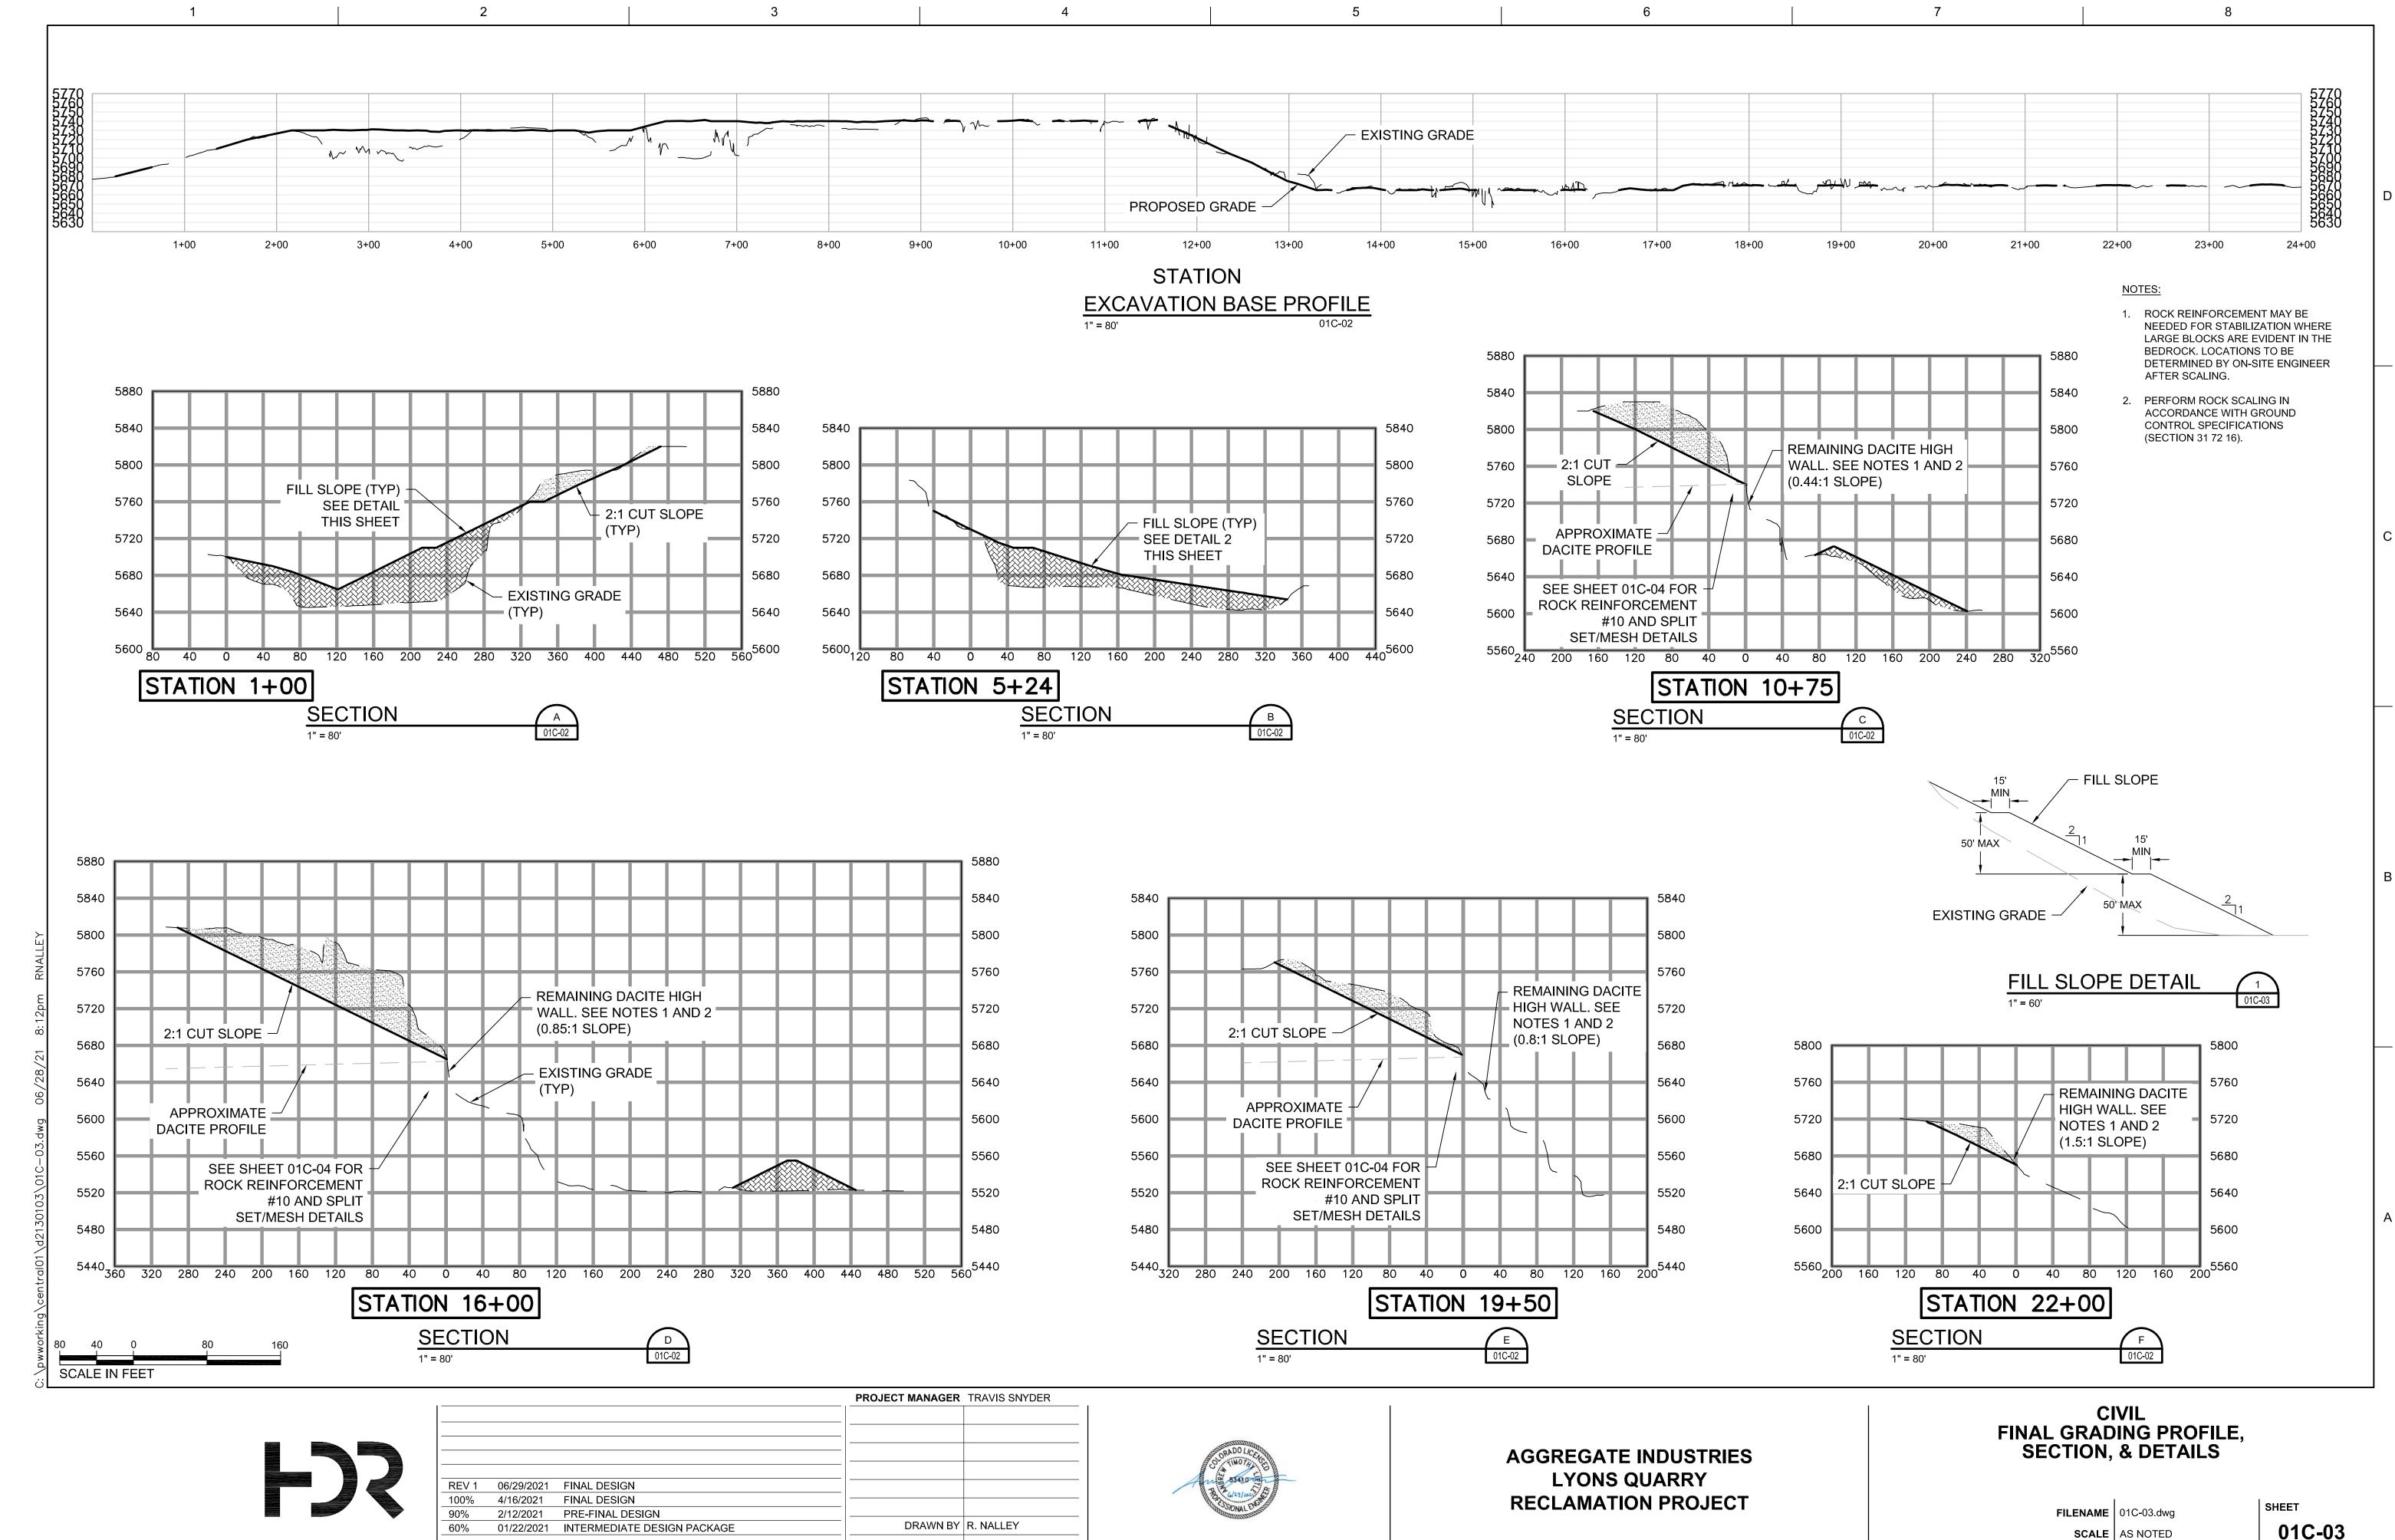

PROJECT NUMBER | 10092468

01C-03

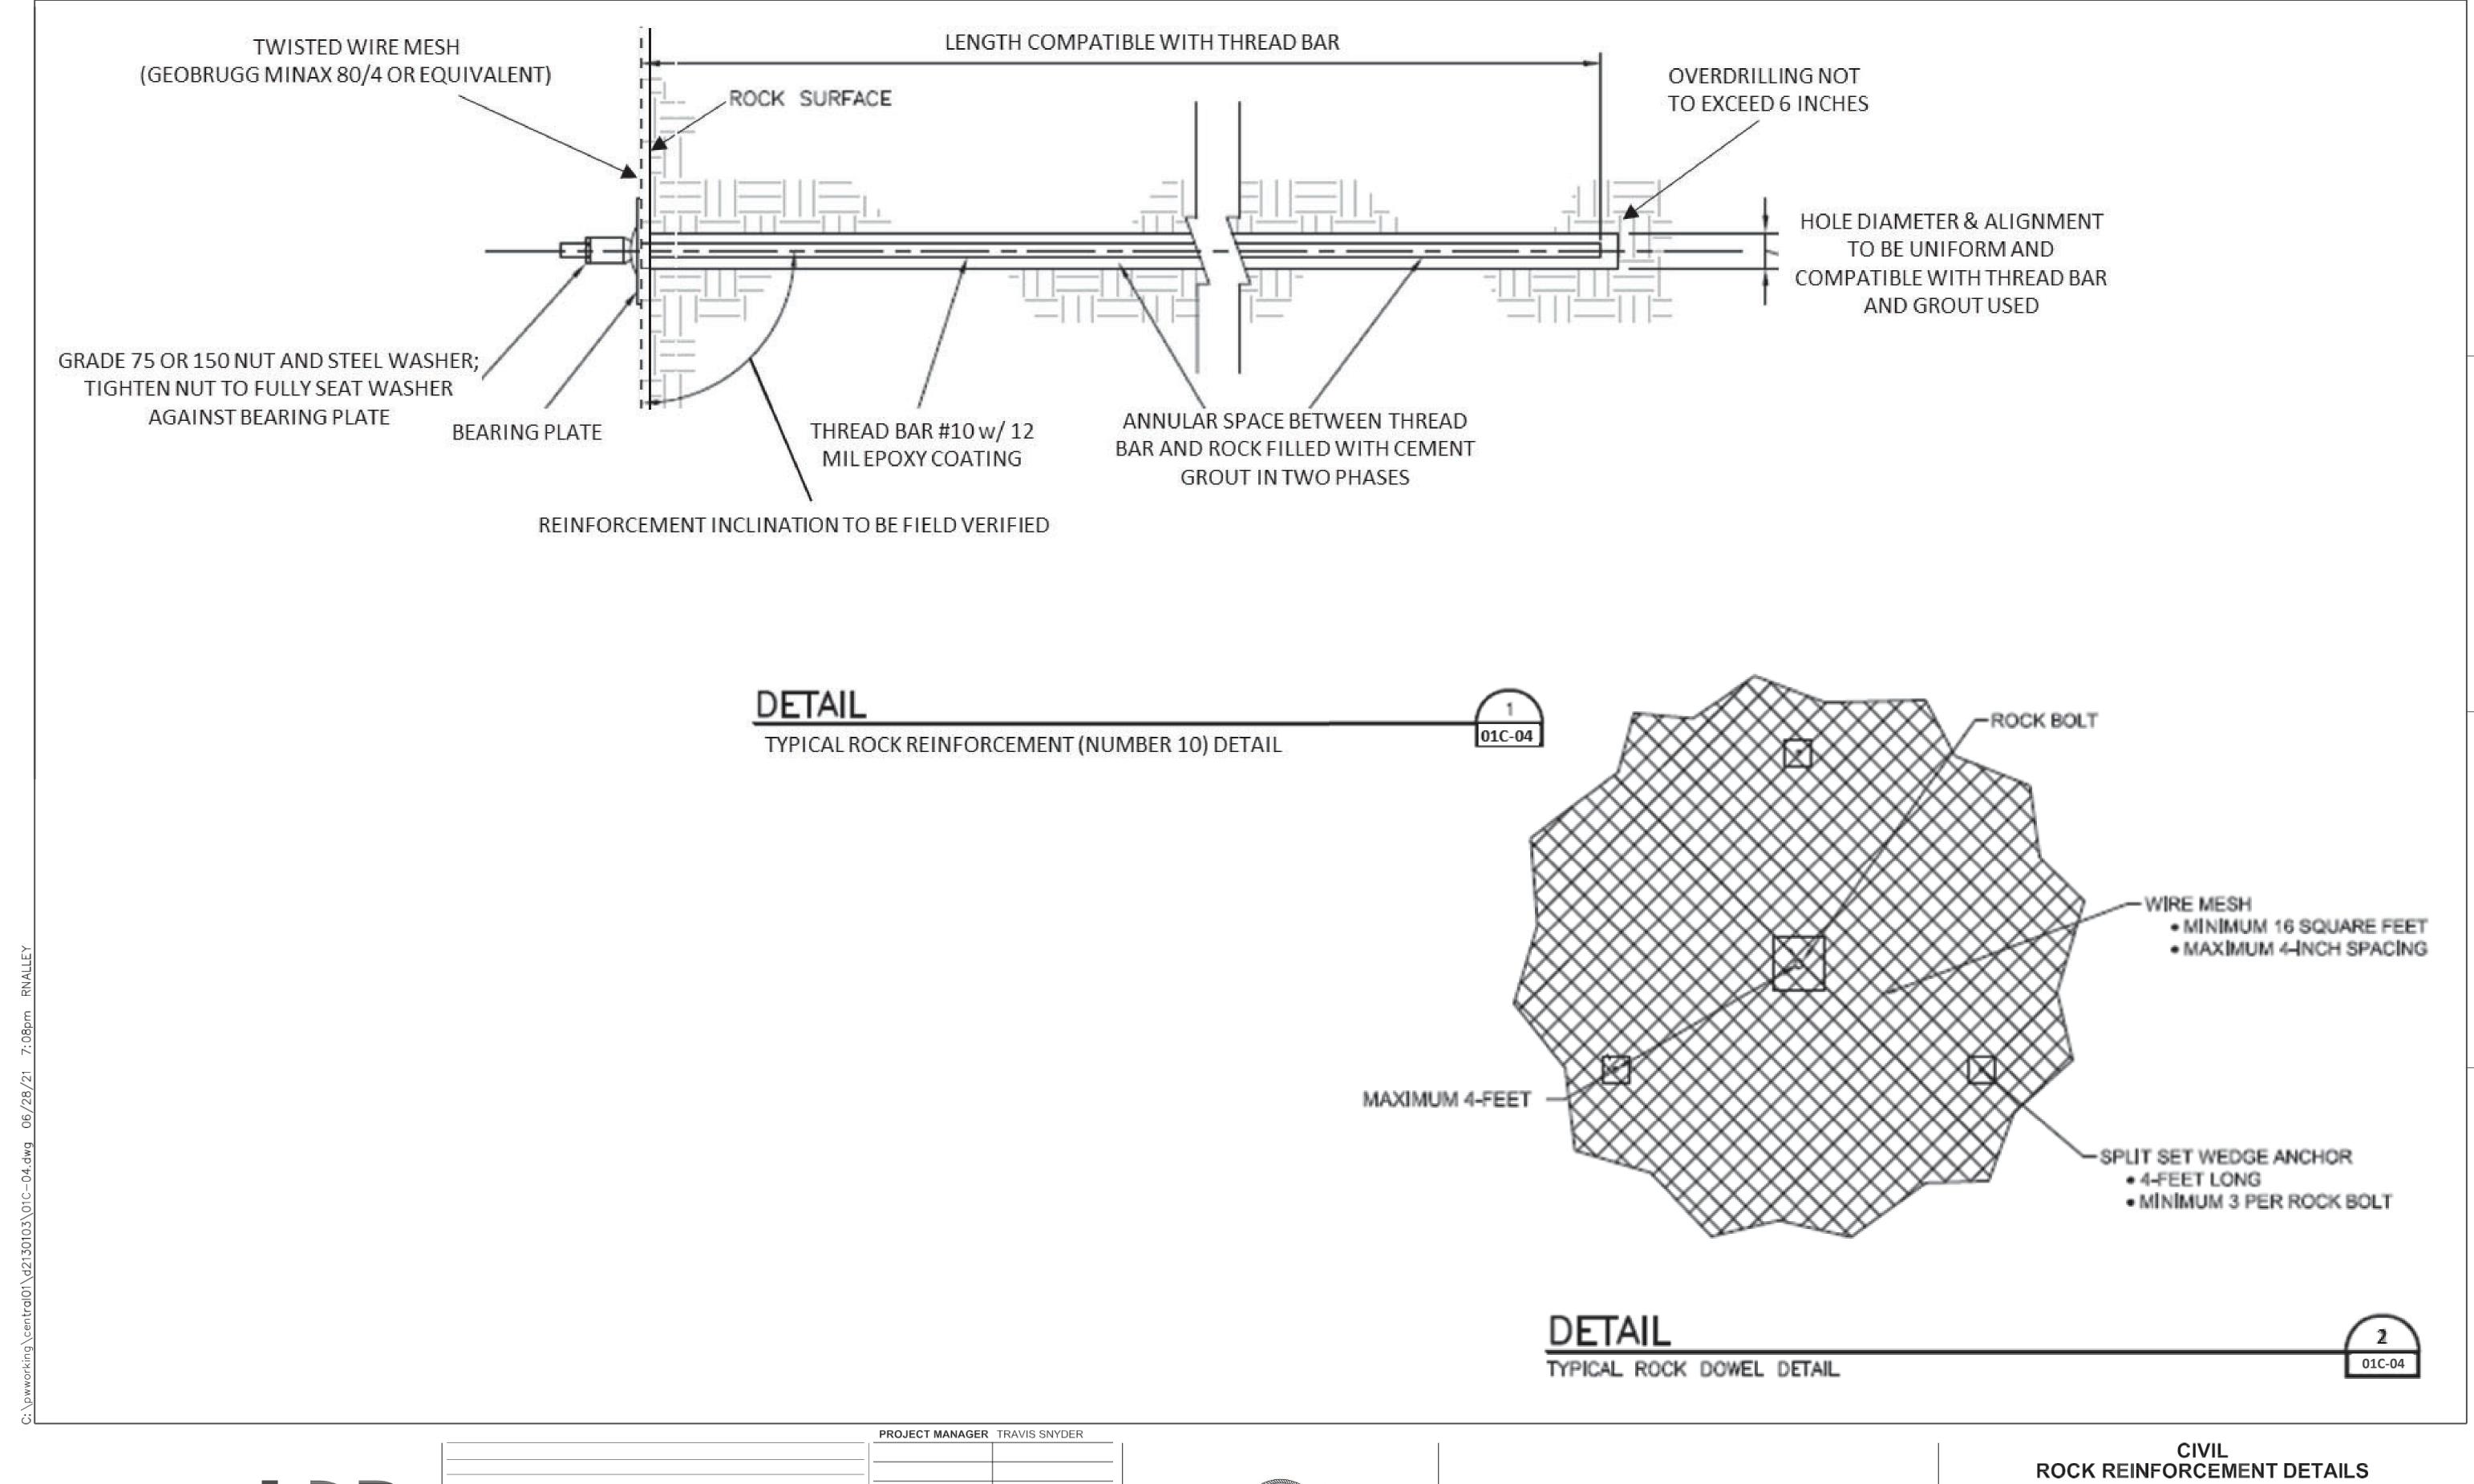


REV 1 06/29/2021 FINAL DESIGN DRAWN BY R. NALLEY DESCRIPTION PROJECT NUMBER | 10092468




AGGREGATE INDUSTRIES LYONS QUARRY **RECLAMATION PROJECT**

FILENAME 01C-04.dwg SCALE NTS

01C-04

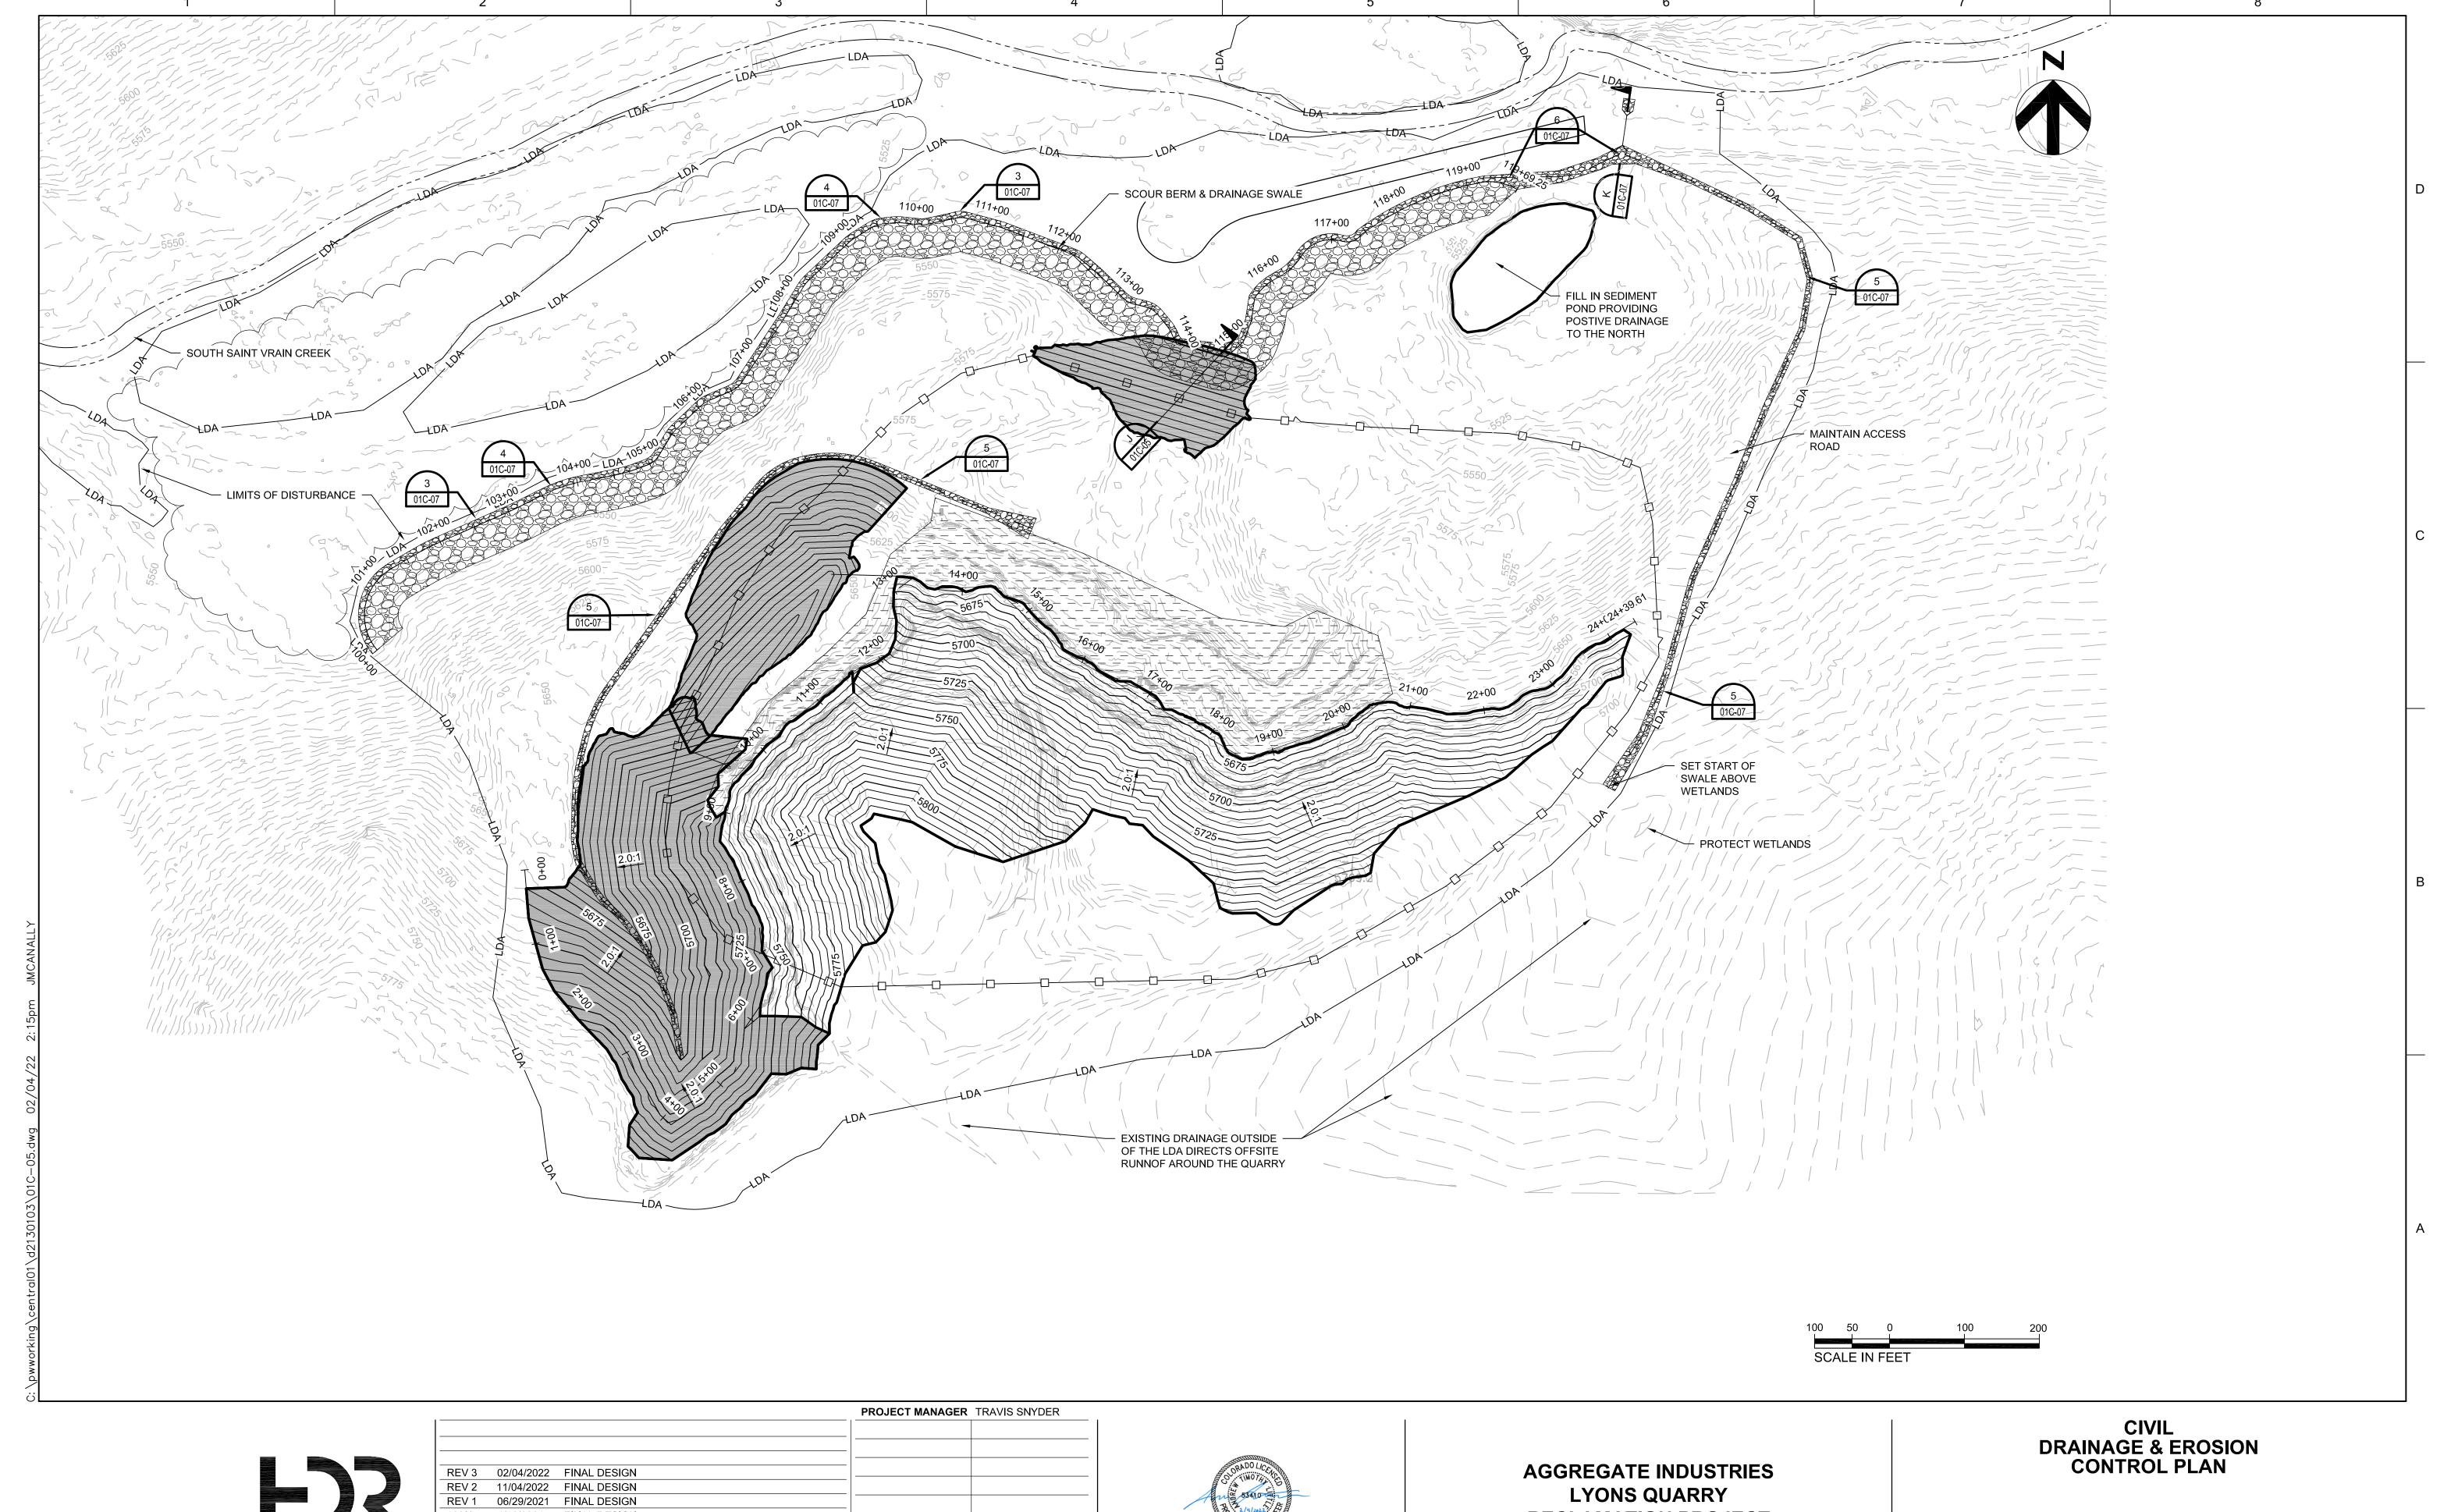

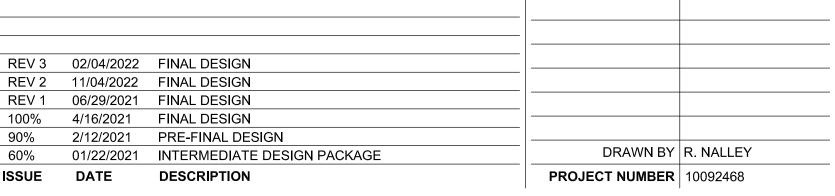





RECLAMATION PROJECT

FILENAME 01C-05.dwg SCALE AS NOTED


01C-05

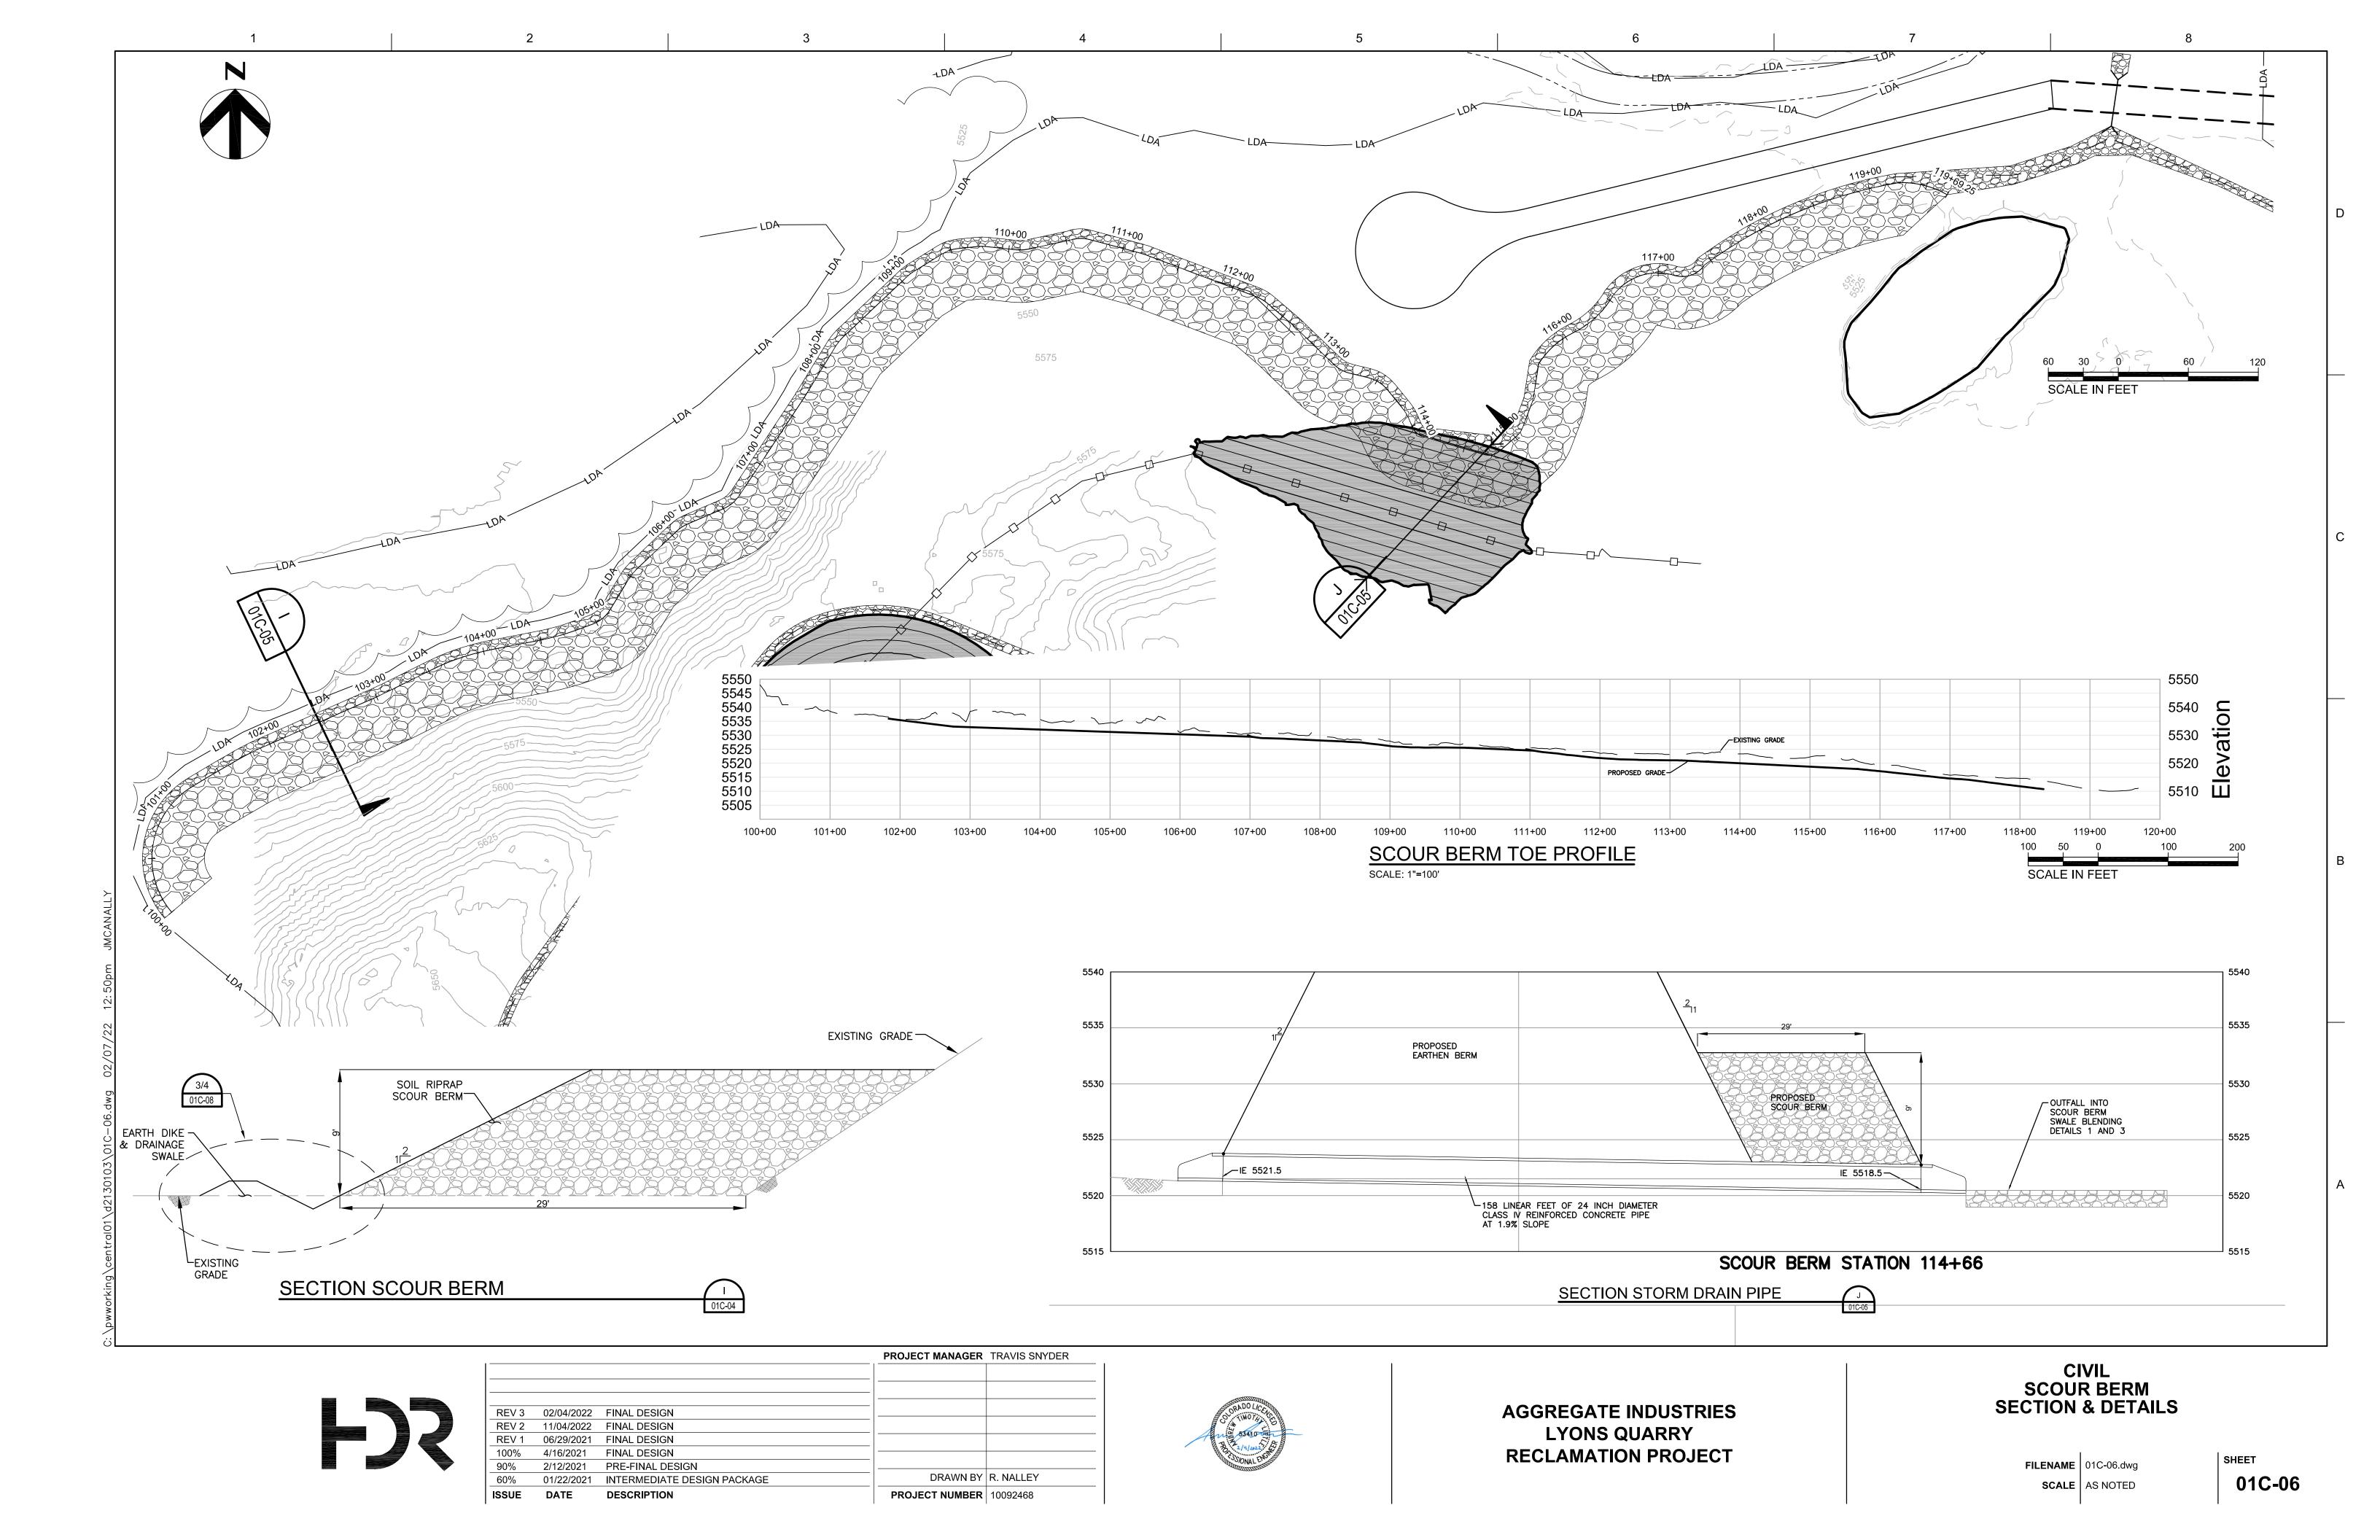

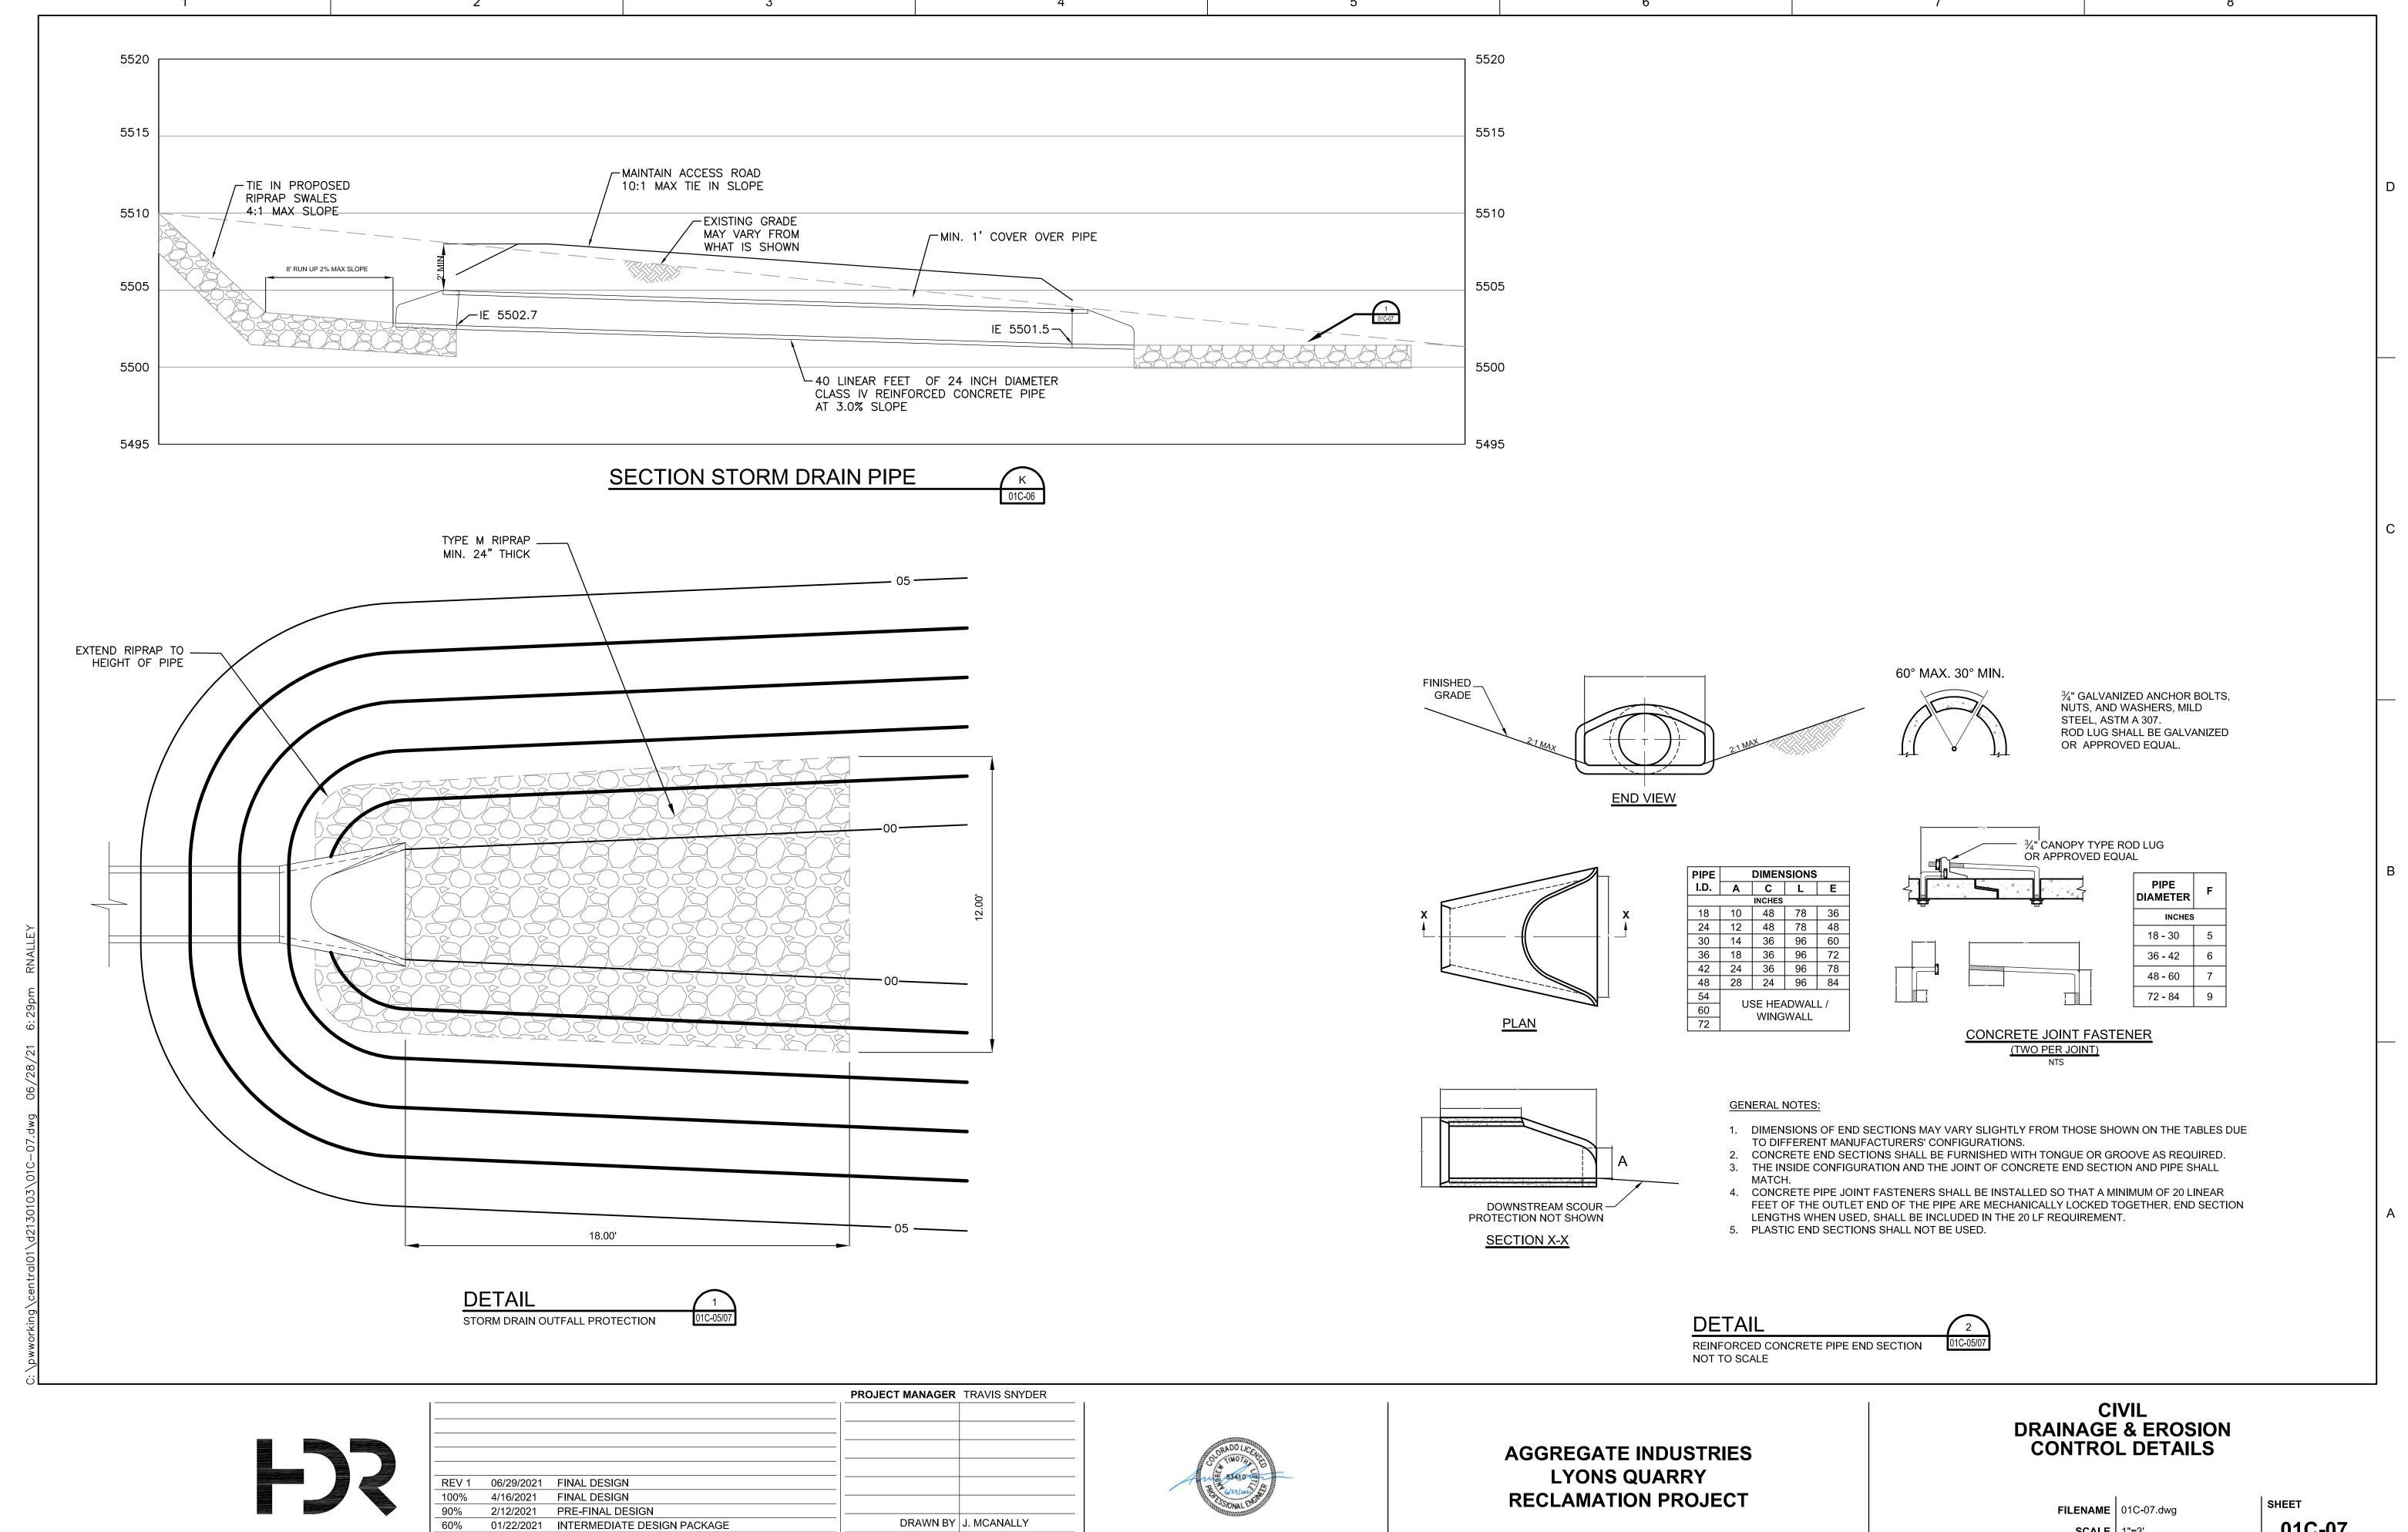

PROJECT NUMBER | 10092468

01C-07 SCALE | 1"=3'

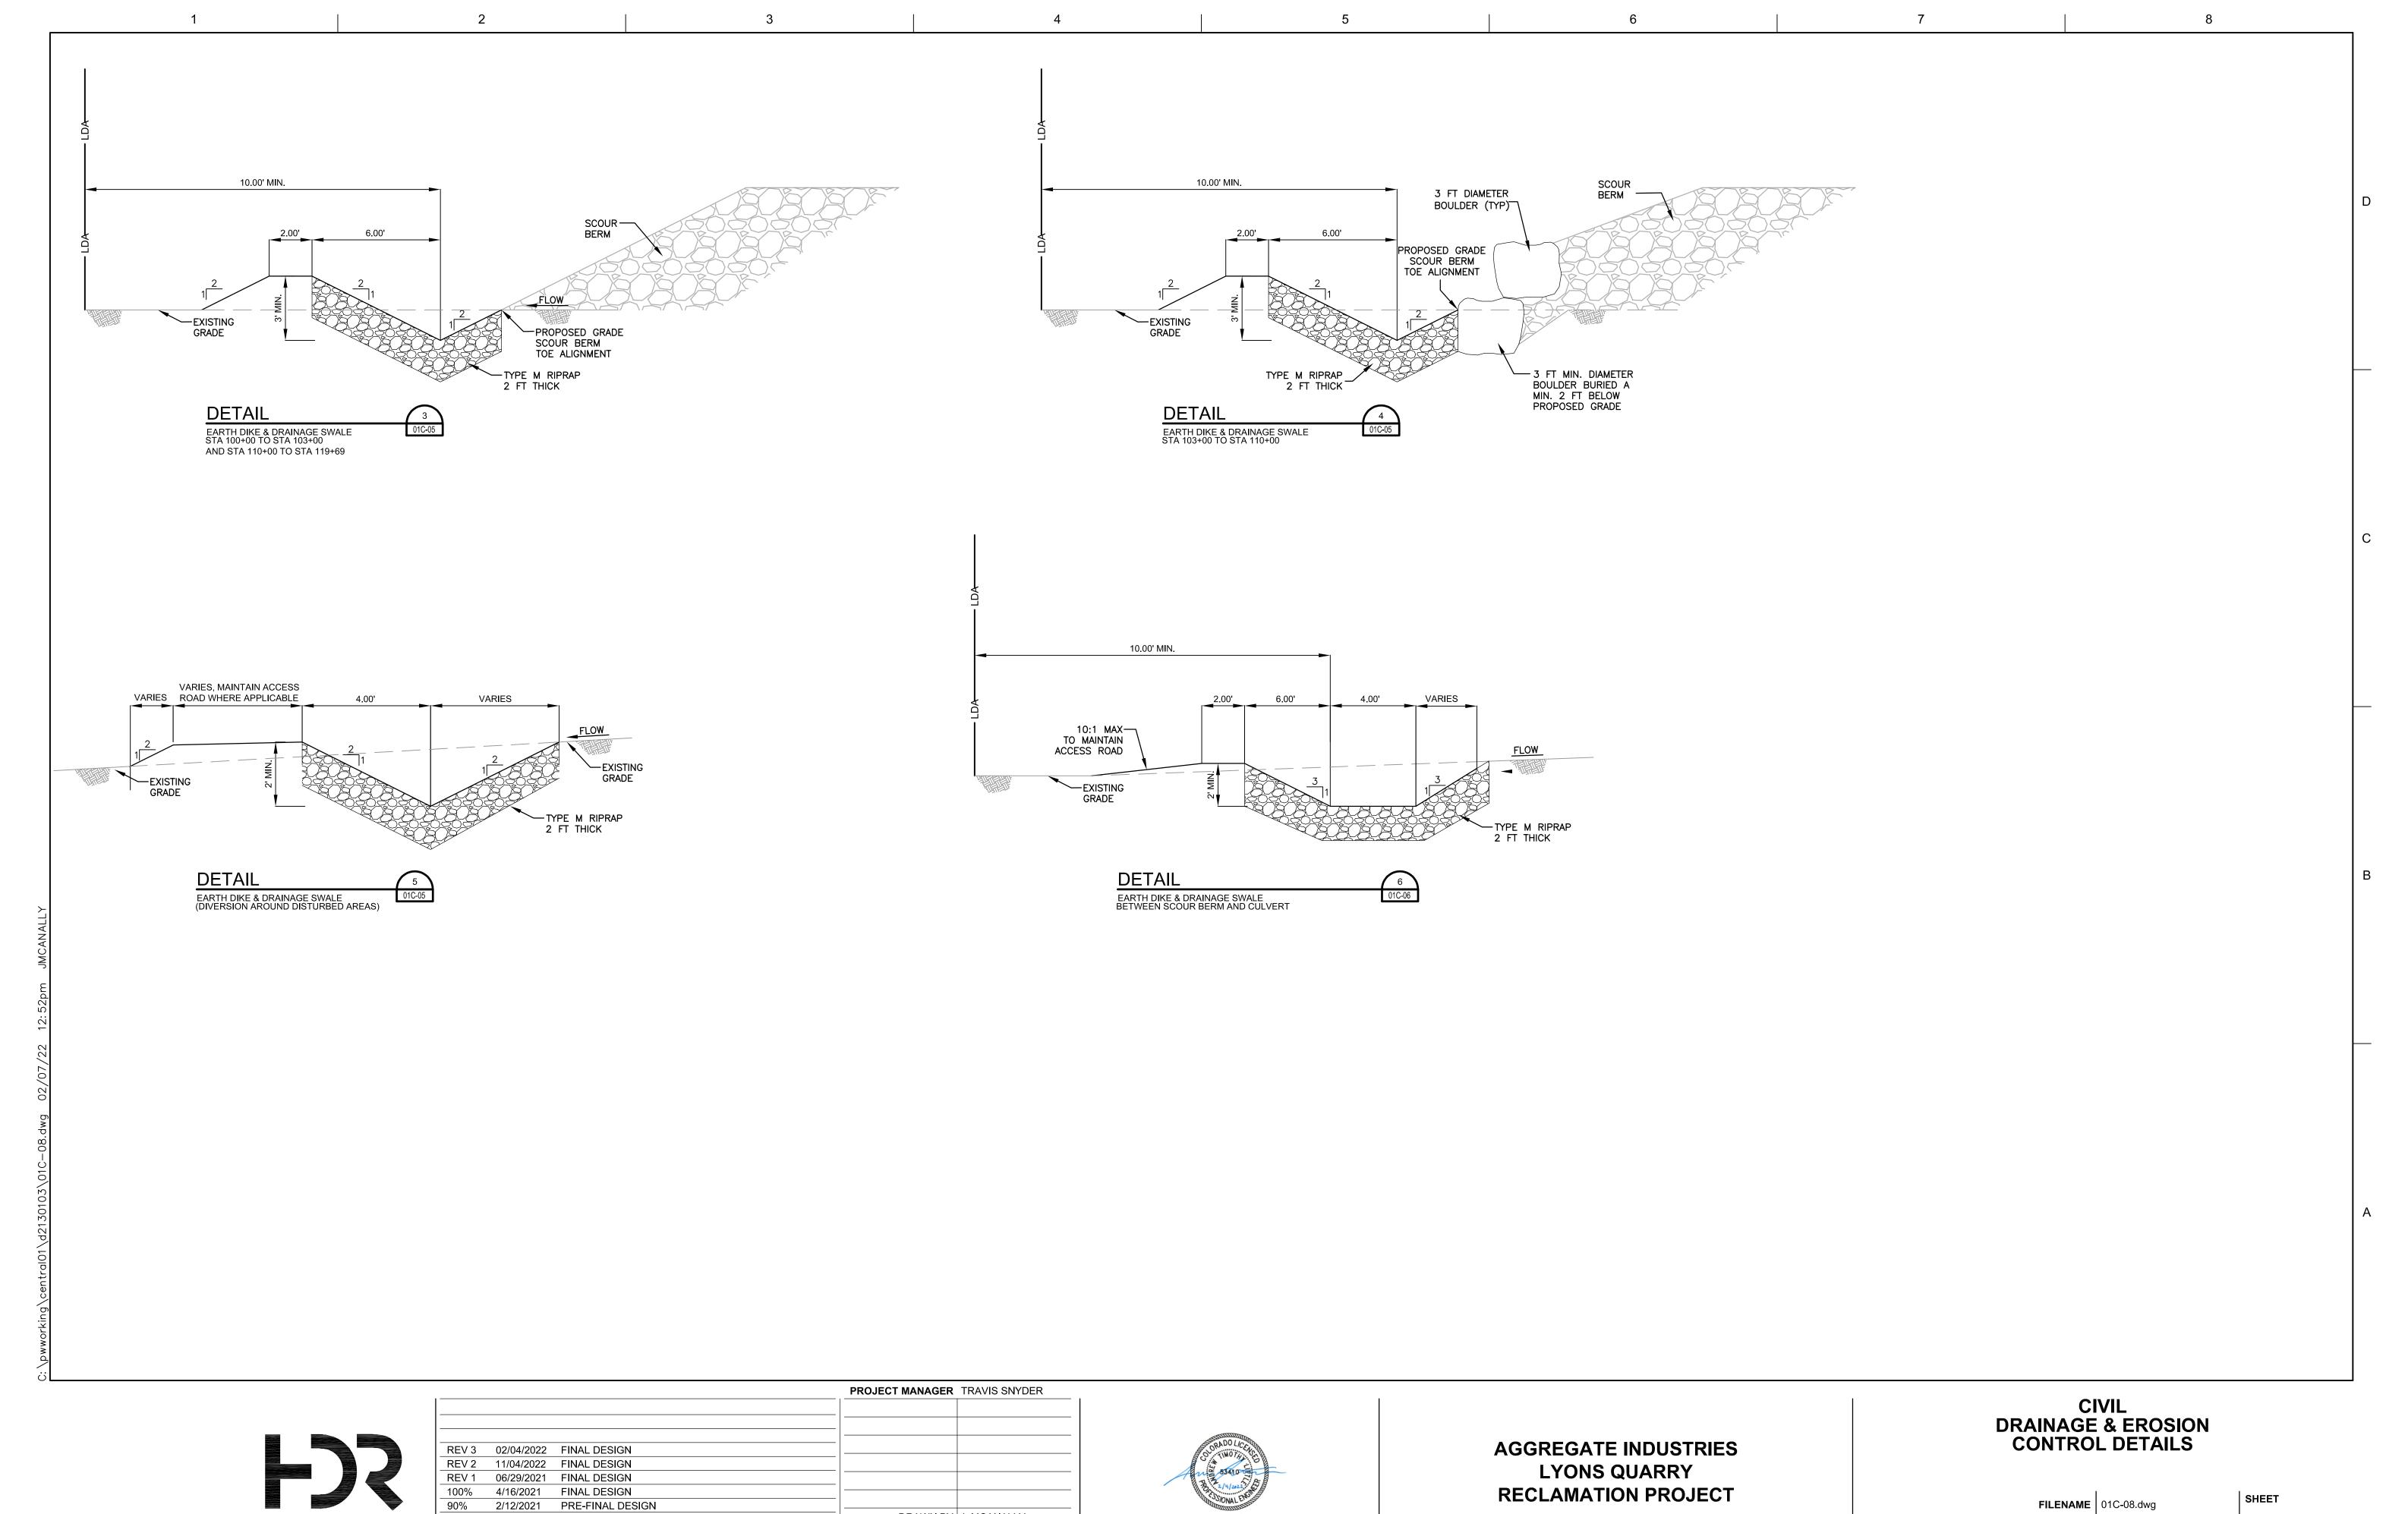

DRAWN BY J. MCANALLY

PROJECT NUMBER | 10092468

01/22/2021 INTERMEDIATE DESIGN PACKAGE

SCALE NTS SHEET 01C-08.dwg 01C-08.dwg



DRAWN BY R. NALLEY

PROJECT NUMBER | 10092468

SCALE AS NOTED SHEET 01C-09.dwg 01C-09