# DENVER WATER DENVER, COLORADO


LUPTON LAKES

INLET/OUTLET FACILITY
CONTRACT 504380

BOARD OF WATER COMMISSIONERS
DENVER, COLORADO

H. Gregory Austin — President James S. Lochhead — CEO/Manager


Robert J. Mahoney - Chief Engineering Officer-

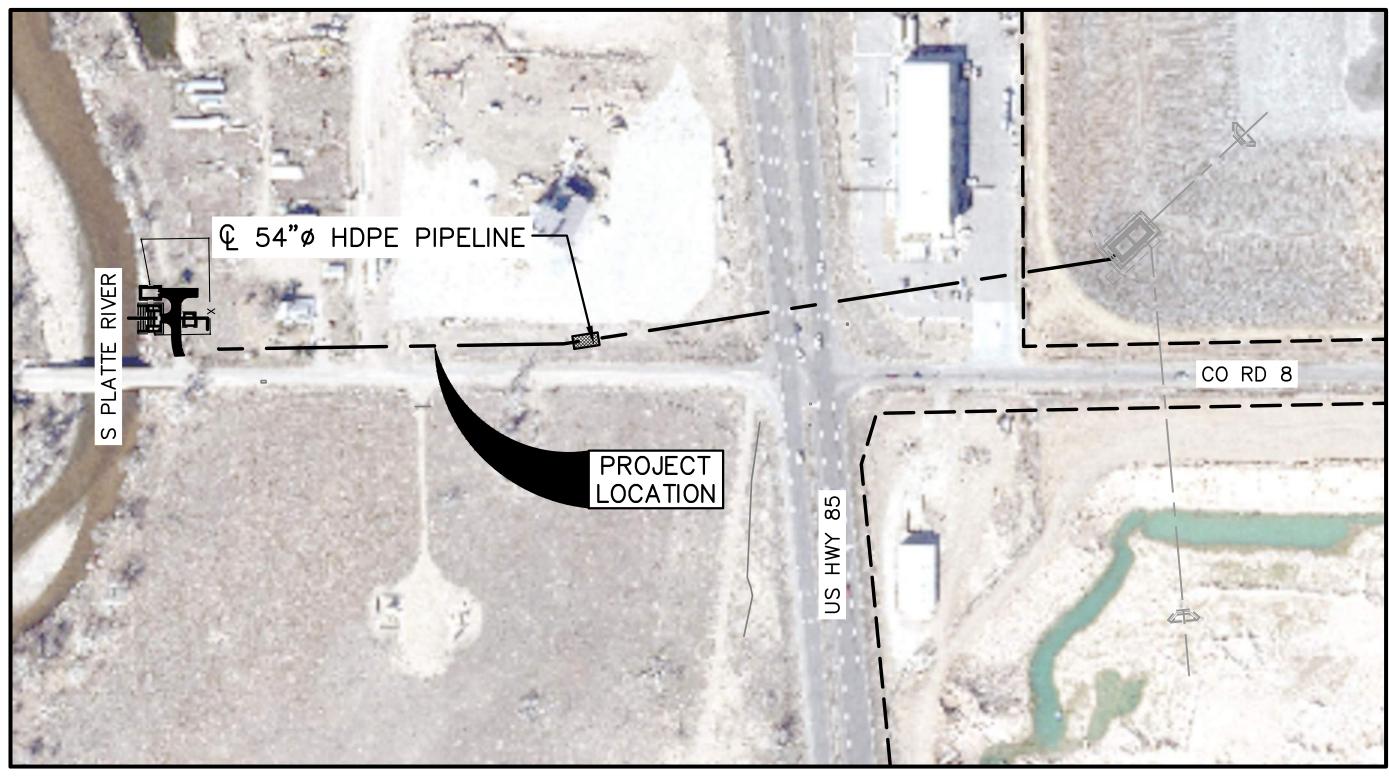

VICINITY MAP

SCALE 1" = 150'

\* GRAYSCALE INDICATES FUTURE WORK

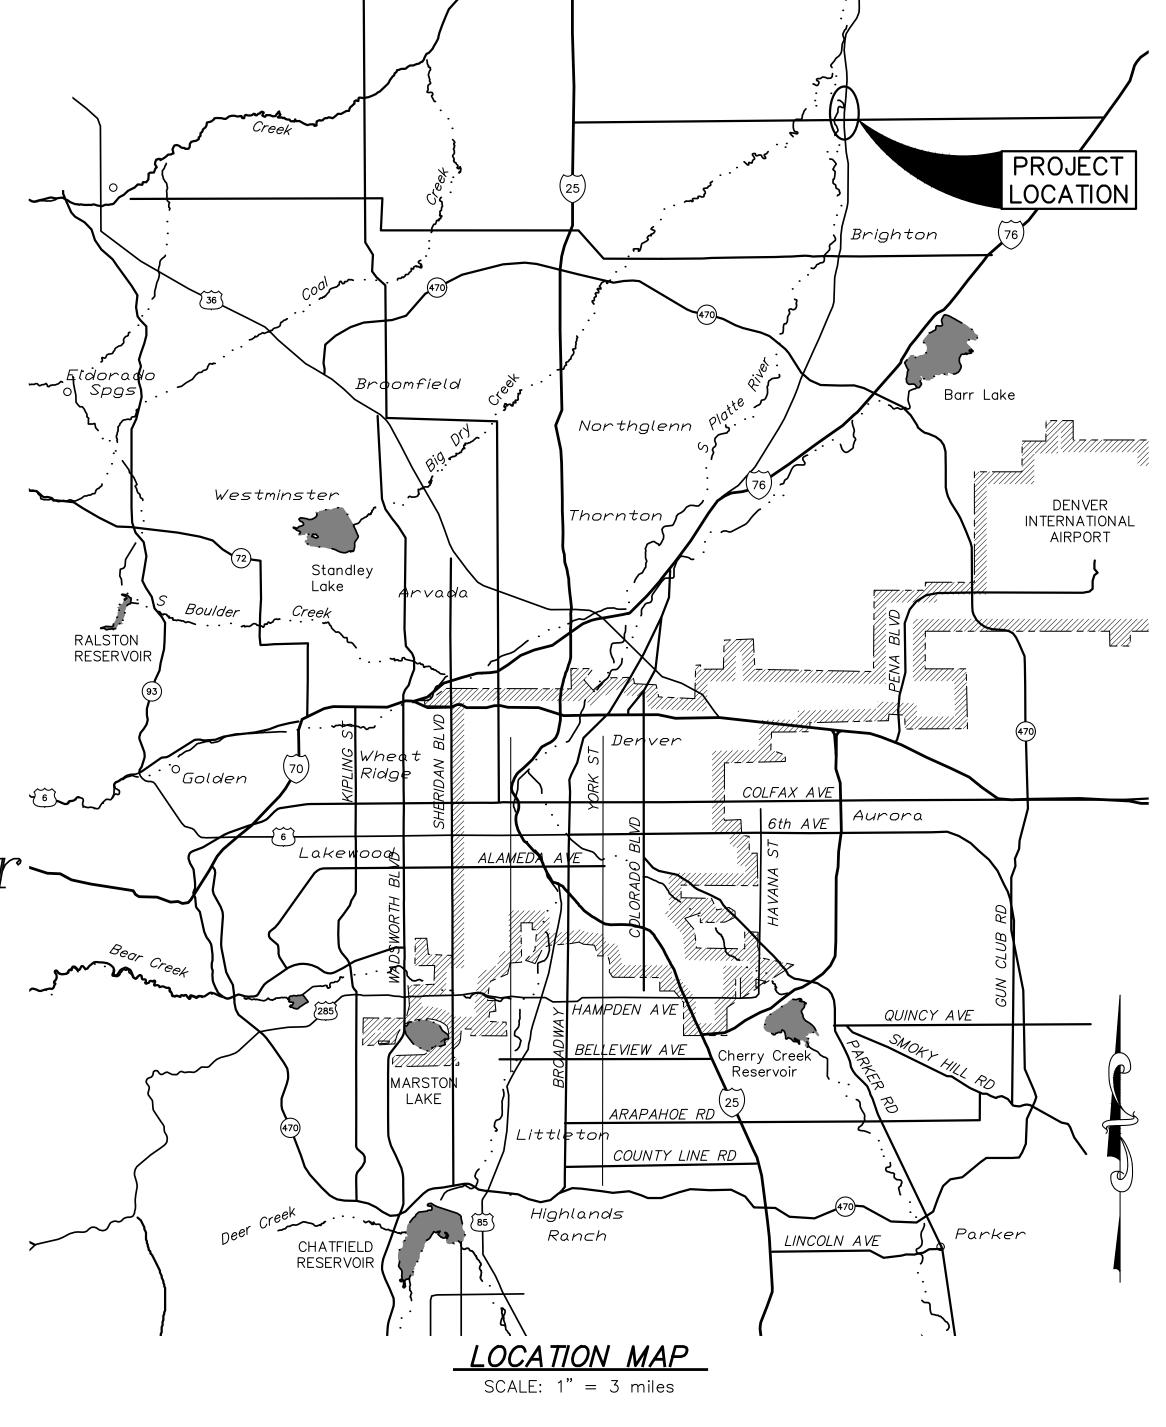

### PROJECT DIRECTORY

UTILITY OWNER: DENVER WATER 1600 W 12th AVE DENVER, CO 80204 303-628-6000

CONTACT:
DESIGN PROJECT MANAGER
BRAD PIEDE, PE
303-628-6756
Brad.Piede@denverwater.org



DENVER WATER

1600 West 12th Ave Denver, Colorado 80204-3412 T: 303.628.6000 F: 303.628.6851

CONSULTAN

## **AECOM**

7595 TECHNOLOGY WAY, SUITE 1 DENVER, CO 80237 303 694-2770 (phone) 303-694-3946 (fax)



LUPTON LAKES

INLET/OUTLET FACILITY

REFERENCE:
CAPITAL PROJECTS CONSTRUCTION

TANDARDS 3rd Edition

THIS DRAWING IS BASED ON THE DW\_FT LUPTON\_GRID COORDINATE SYSTEM

\(\triangle \) 12/16/20 FINAL FOR CONSTRUCTION

No Date Description REVISIONS

## **VERIFY SCALES**

BAR IS ONE INCH ON ORIGINAL DRAWING

O 1'

IF NOT ONE INCH ON THIS SHEET, ADJUST SCALES ACCORDINGLY

DRAWN BY: SM/DS

SB
CHKD BY: S BERZINS/B PIEDE

SC DITO

APPD BY:

DATE: *FEBRUARY 2020*CONTRACT: *504380* 


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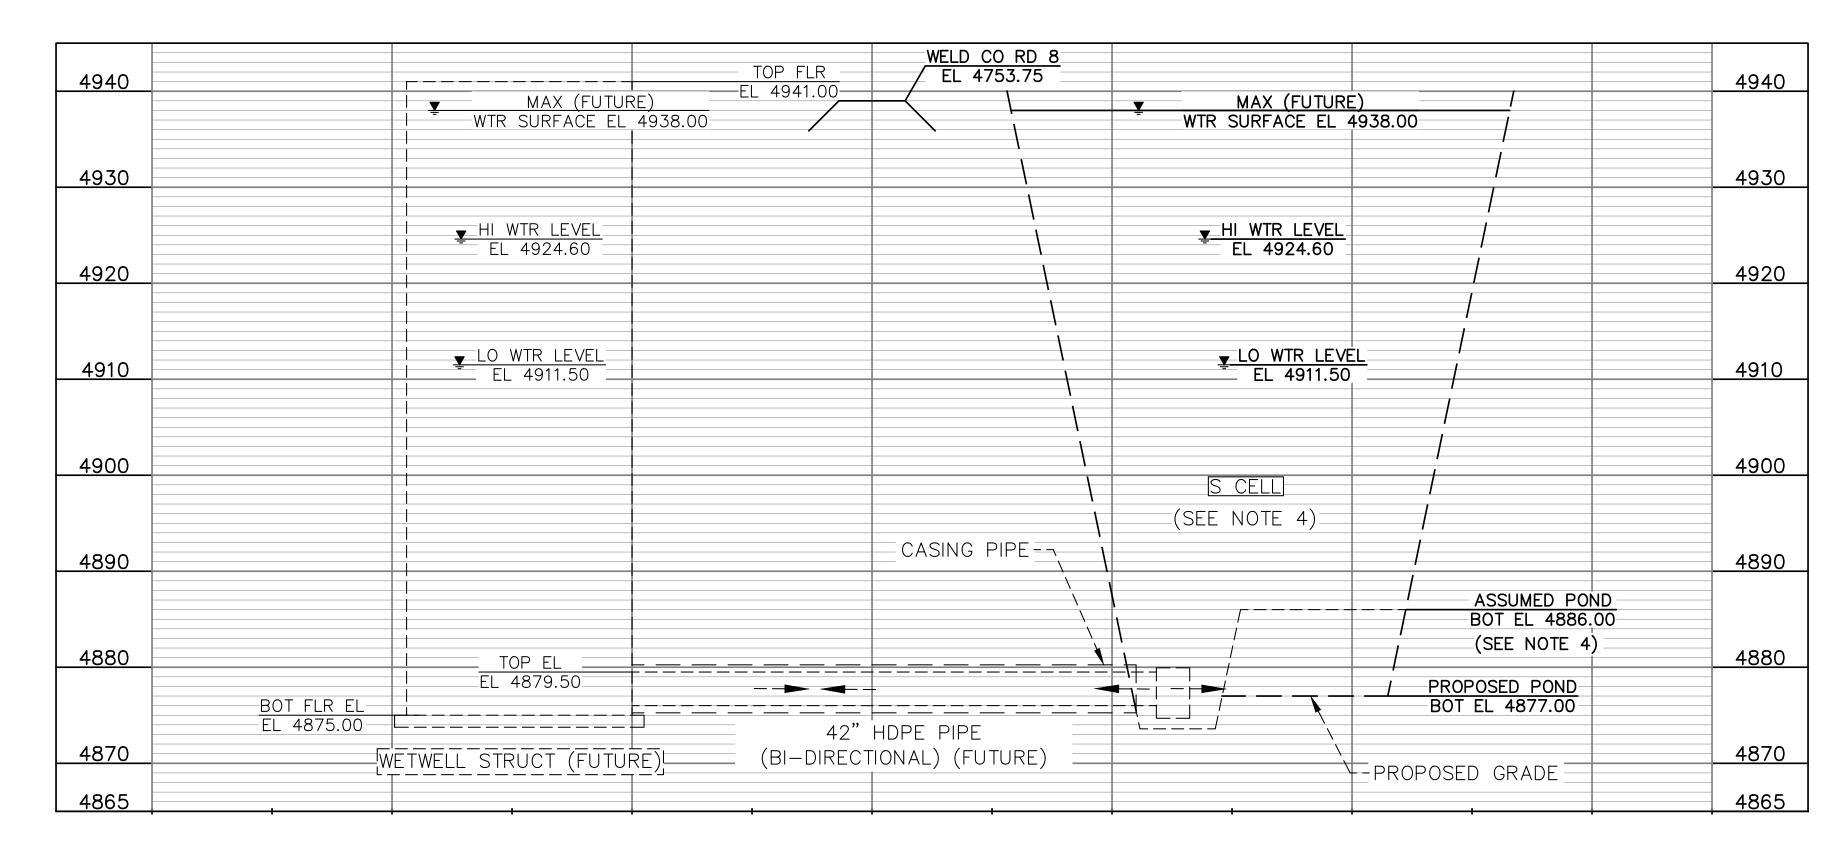
DRAWING TITLE

COVER SHEET

G-1




# <u>HYDRAULIC PROFILE</u> INLET STRUCTURE TO NORTH CELL

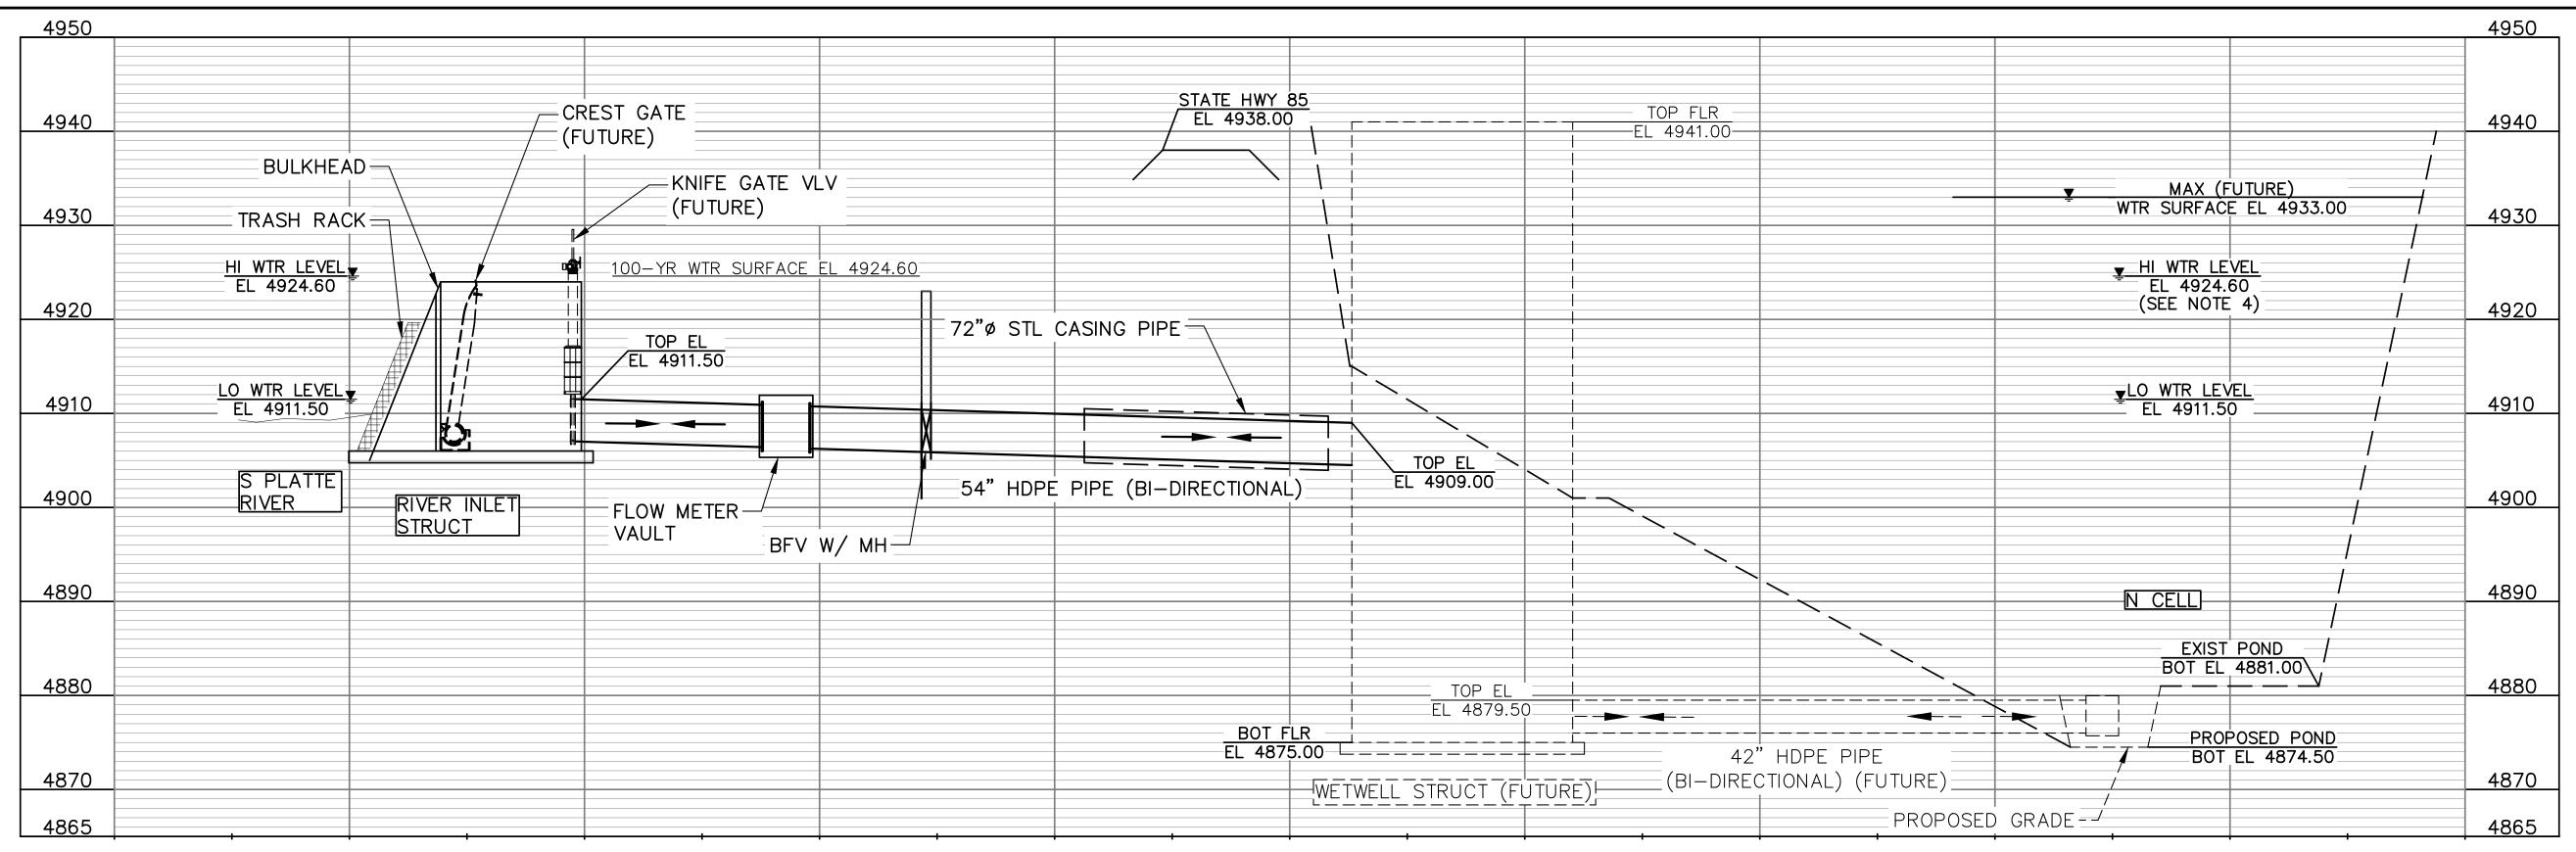

## NOTES:

- 1. SYSTEM ELEVATION BASED ON SURVEY PROVIDED BY DENVER WATER ON DECEMBER 6, 2019, SEE DWG G-7 FOR DETAILS.
- 2. RAW WATER FLOW RATES PROVIDED BY DENVER WATER.
- 3. THE SOUTH CELL IS CURRENTLY AN ACTIVE GRAVEL MINE. FINAL POND DESIGN AND GRADE WILL BE PART OF A FUTURE PROJECT. THE PROPOSED ELEVATIONS ARE BASED ON THE FUTURE DESIGN CONTOURS. ASSUMED BOTTOM BASED ON BEDROCK DEPTH.
- 4. THE WATER SURFACE ELEVATION FOR THIS PROJECT WILL VARY BASED ON SOUTH PLATTE RIVER ELEVATION. THE FUTURE MAXIMUM WATER SURFACE ELEVATION WILL BE BASED ON

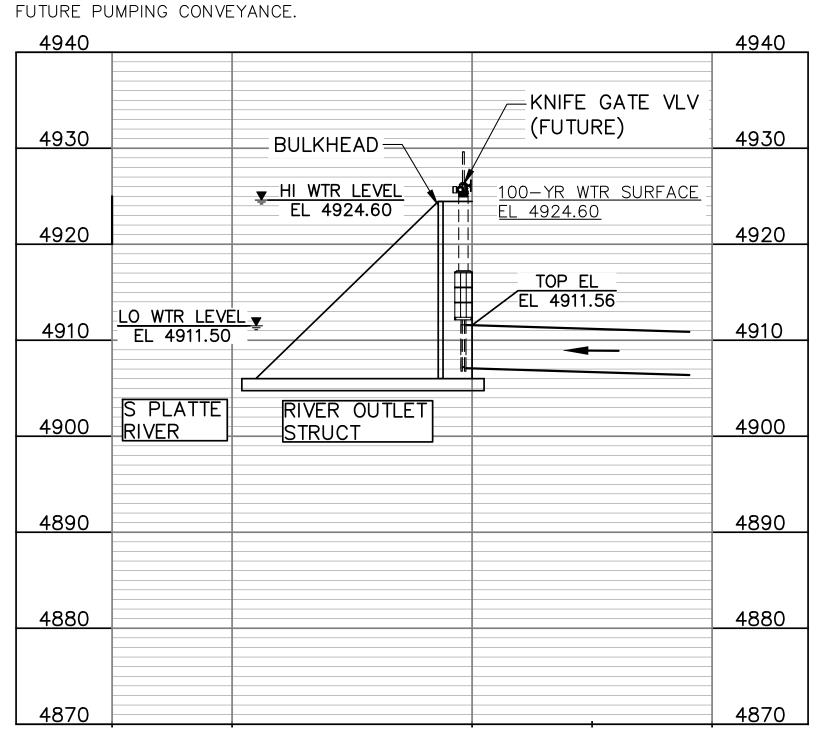

HYDRAULIC PROFILE HYDRAULIC PROFILE OUTLET STRUCT TO TEE WETWELL TO SOUTH CELL (FUTURE)

DENVER WATER

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LUPTON LAKES

INLET/OUTLET FACILITY

REFERENCE: CAPITAL PROJECTS CONSTRUCTION

STANDARDS 3rd Edition

THIS DRAWING IS BASED ON THE DW\_FT

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LUPTON_GRID COORDINATE SYSTEM				

## **VERIFY SCALES**

REVISIONS

BAR IS ONE INCH ON ORIGINAL DRAWING

IF NOT ONE INCH ON THIS SHEET, ADJUST SCALES ACCORDINGLY PT NO: 20123

DRAWN BY: SM/JH

CHKD BY: S BERZINS/B. PIEDE

CHKD BY: S COLE/D. BRINKER APPD BY:

DATE: FEBRUARY 2020 CONTRACT: 504380 AS-BUILT DATE:

AS-BUILT BY: DRAWING TITLE

HYDRAULIC PROFILE

G-4



**PLAN**SCALE: 1" = 60'



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## LUPTON LAKES

INLET/OUTLET FACILITY

## REFERENCE: CAPITAL PROJECTS CONSTRUCTION STANDARDS 3rd Edition

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	LUPTON_GRID COORDINATE SYSTEM				
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No Date Description REVISIONS

### **VERIFY SCALES**

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O 1" 1"

IF NOT ONE INCH ON THIS SHEET, ADJUST SCALES ACCORDINGLY

PT NO: 20123

DRAWN BY: SM/DS

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CHKD BY: S COLE/D BRINKER

APPD BY:

DATE: FEBRUARY 2020

CONTRACT: 504380


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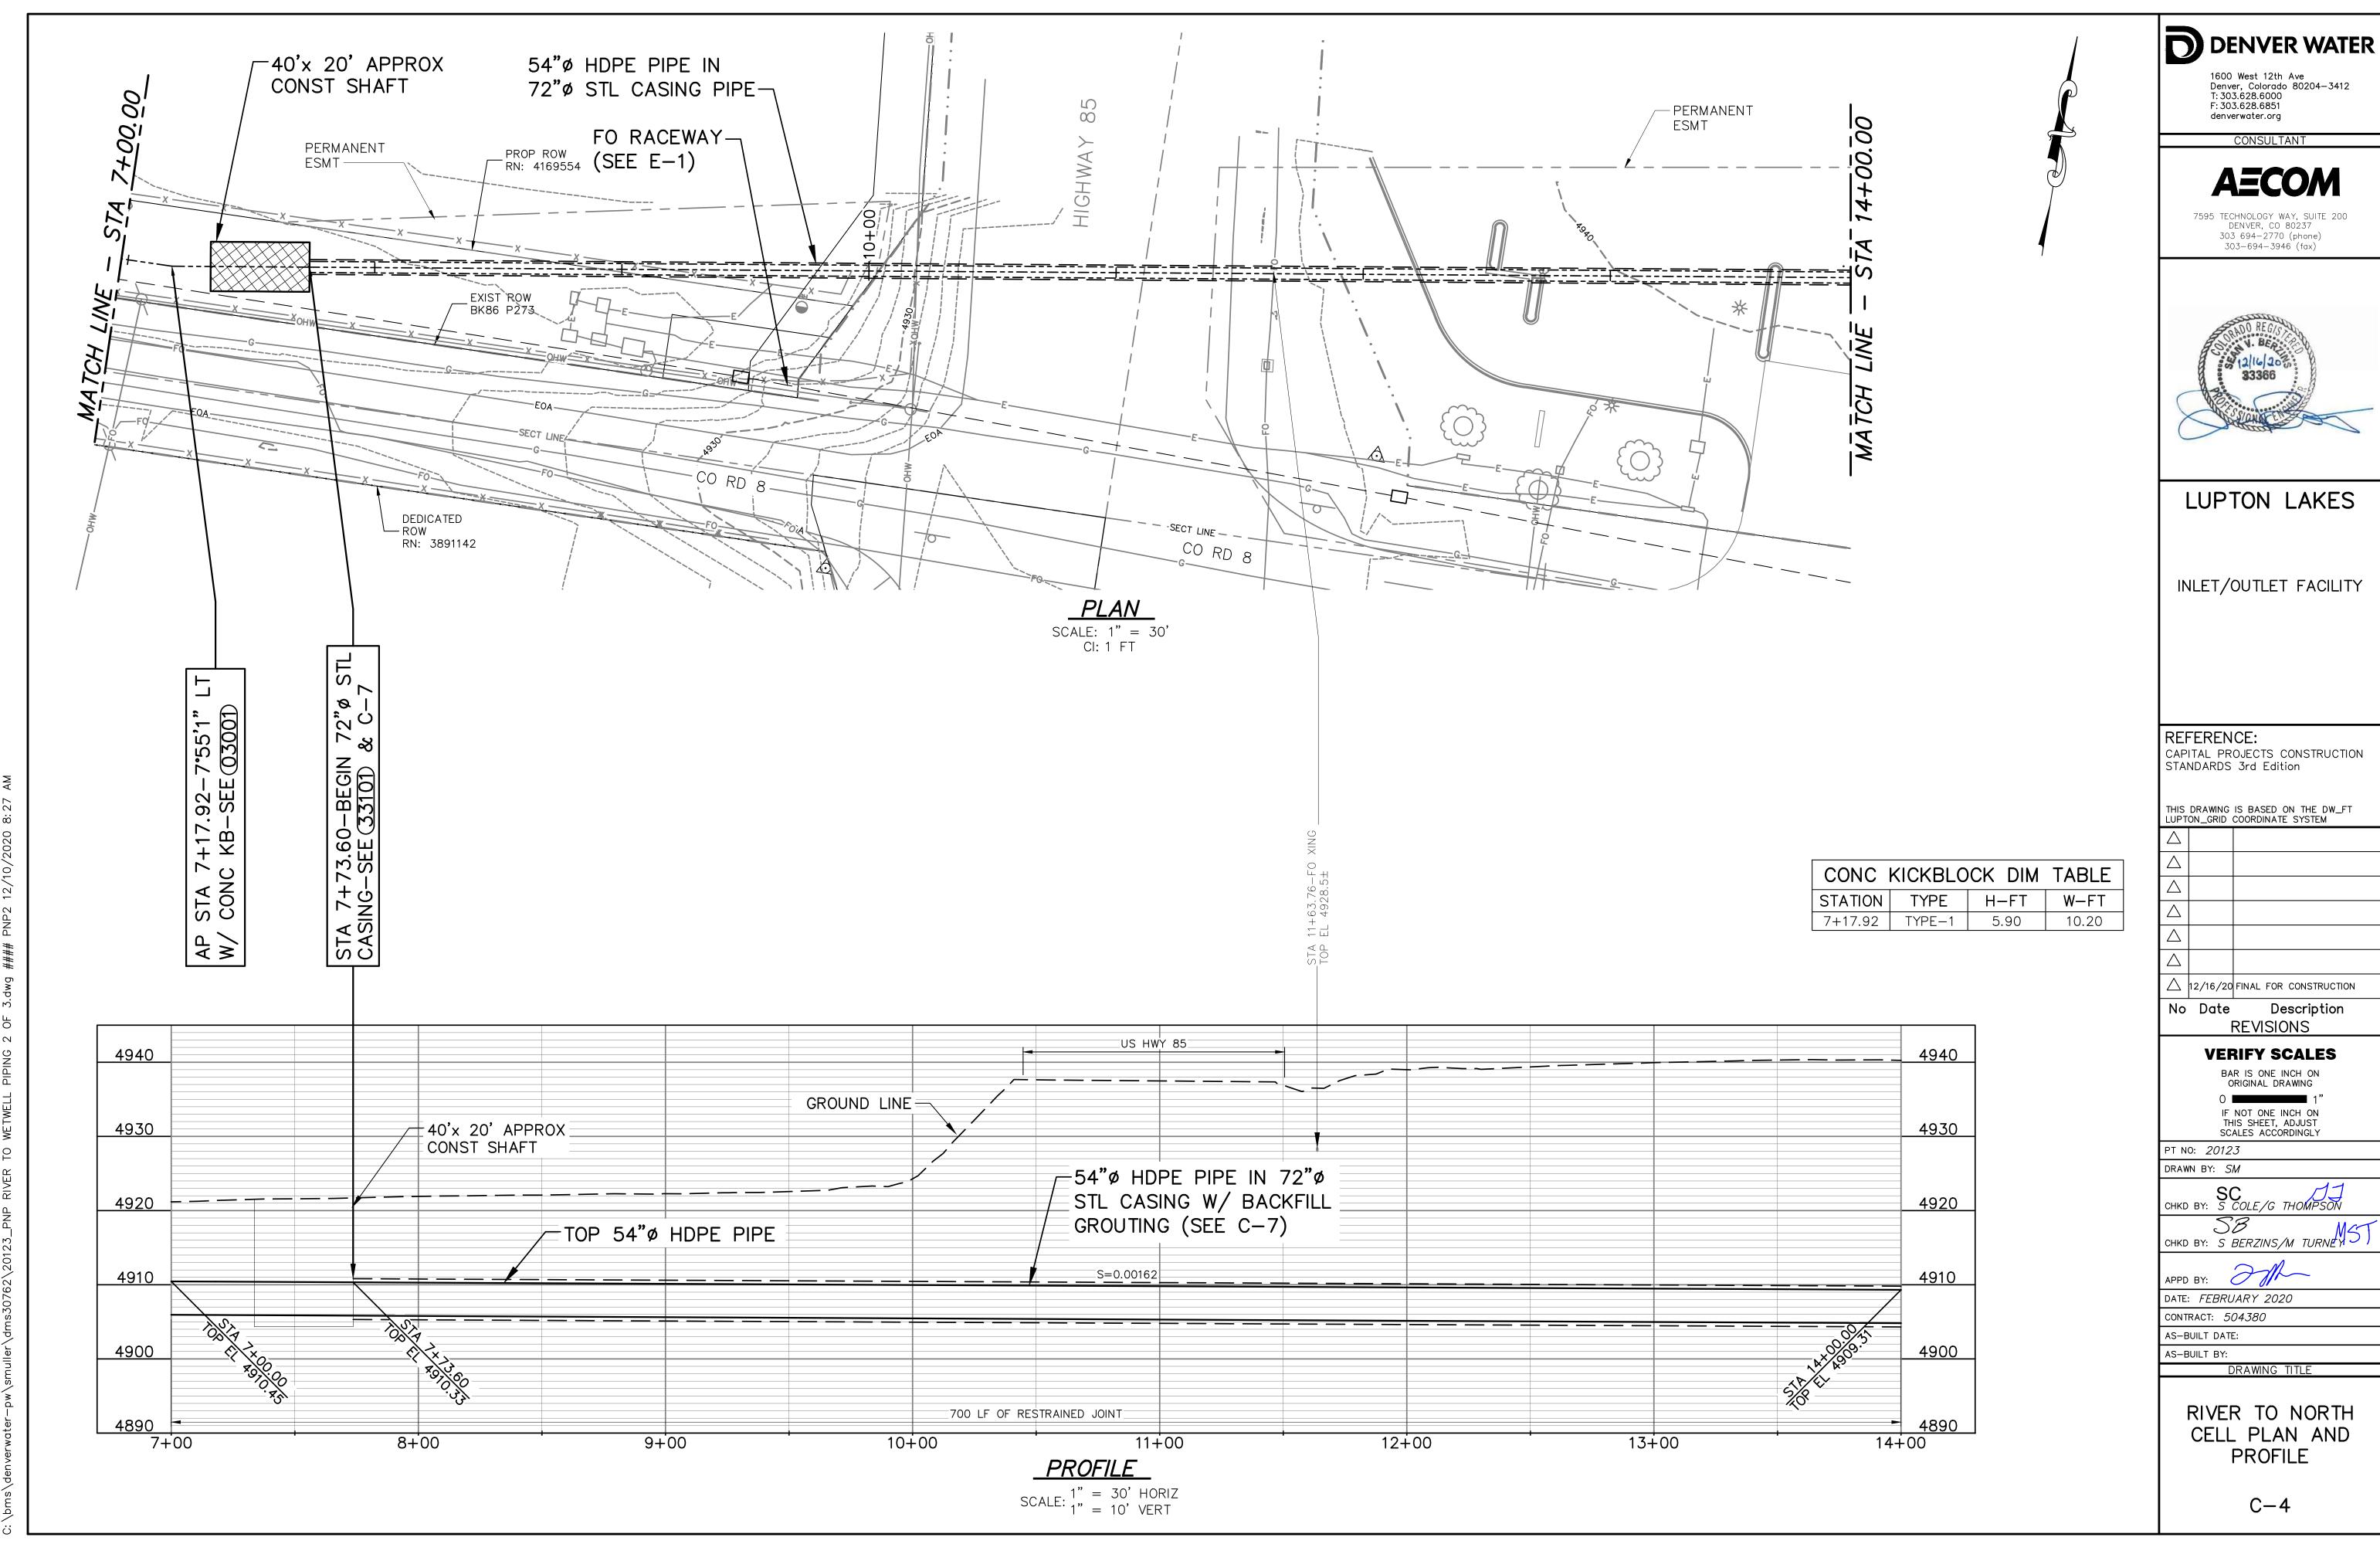
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GEOTECHNICAL PLAN

G-5








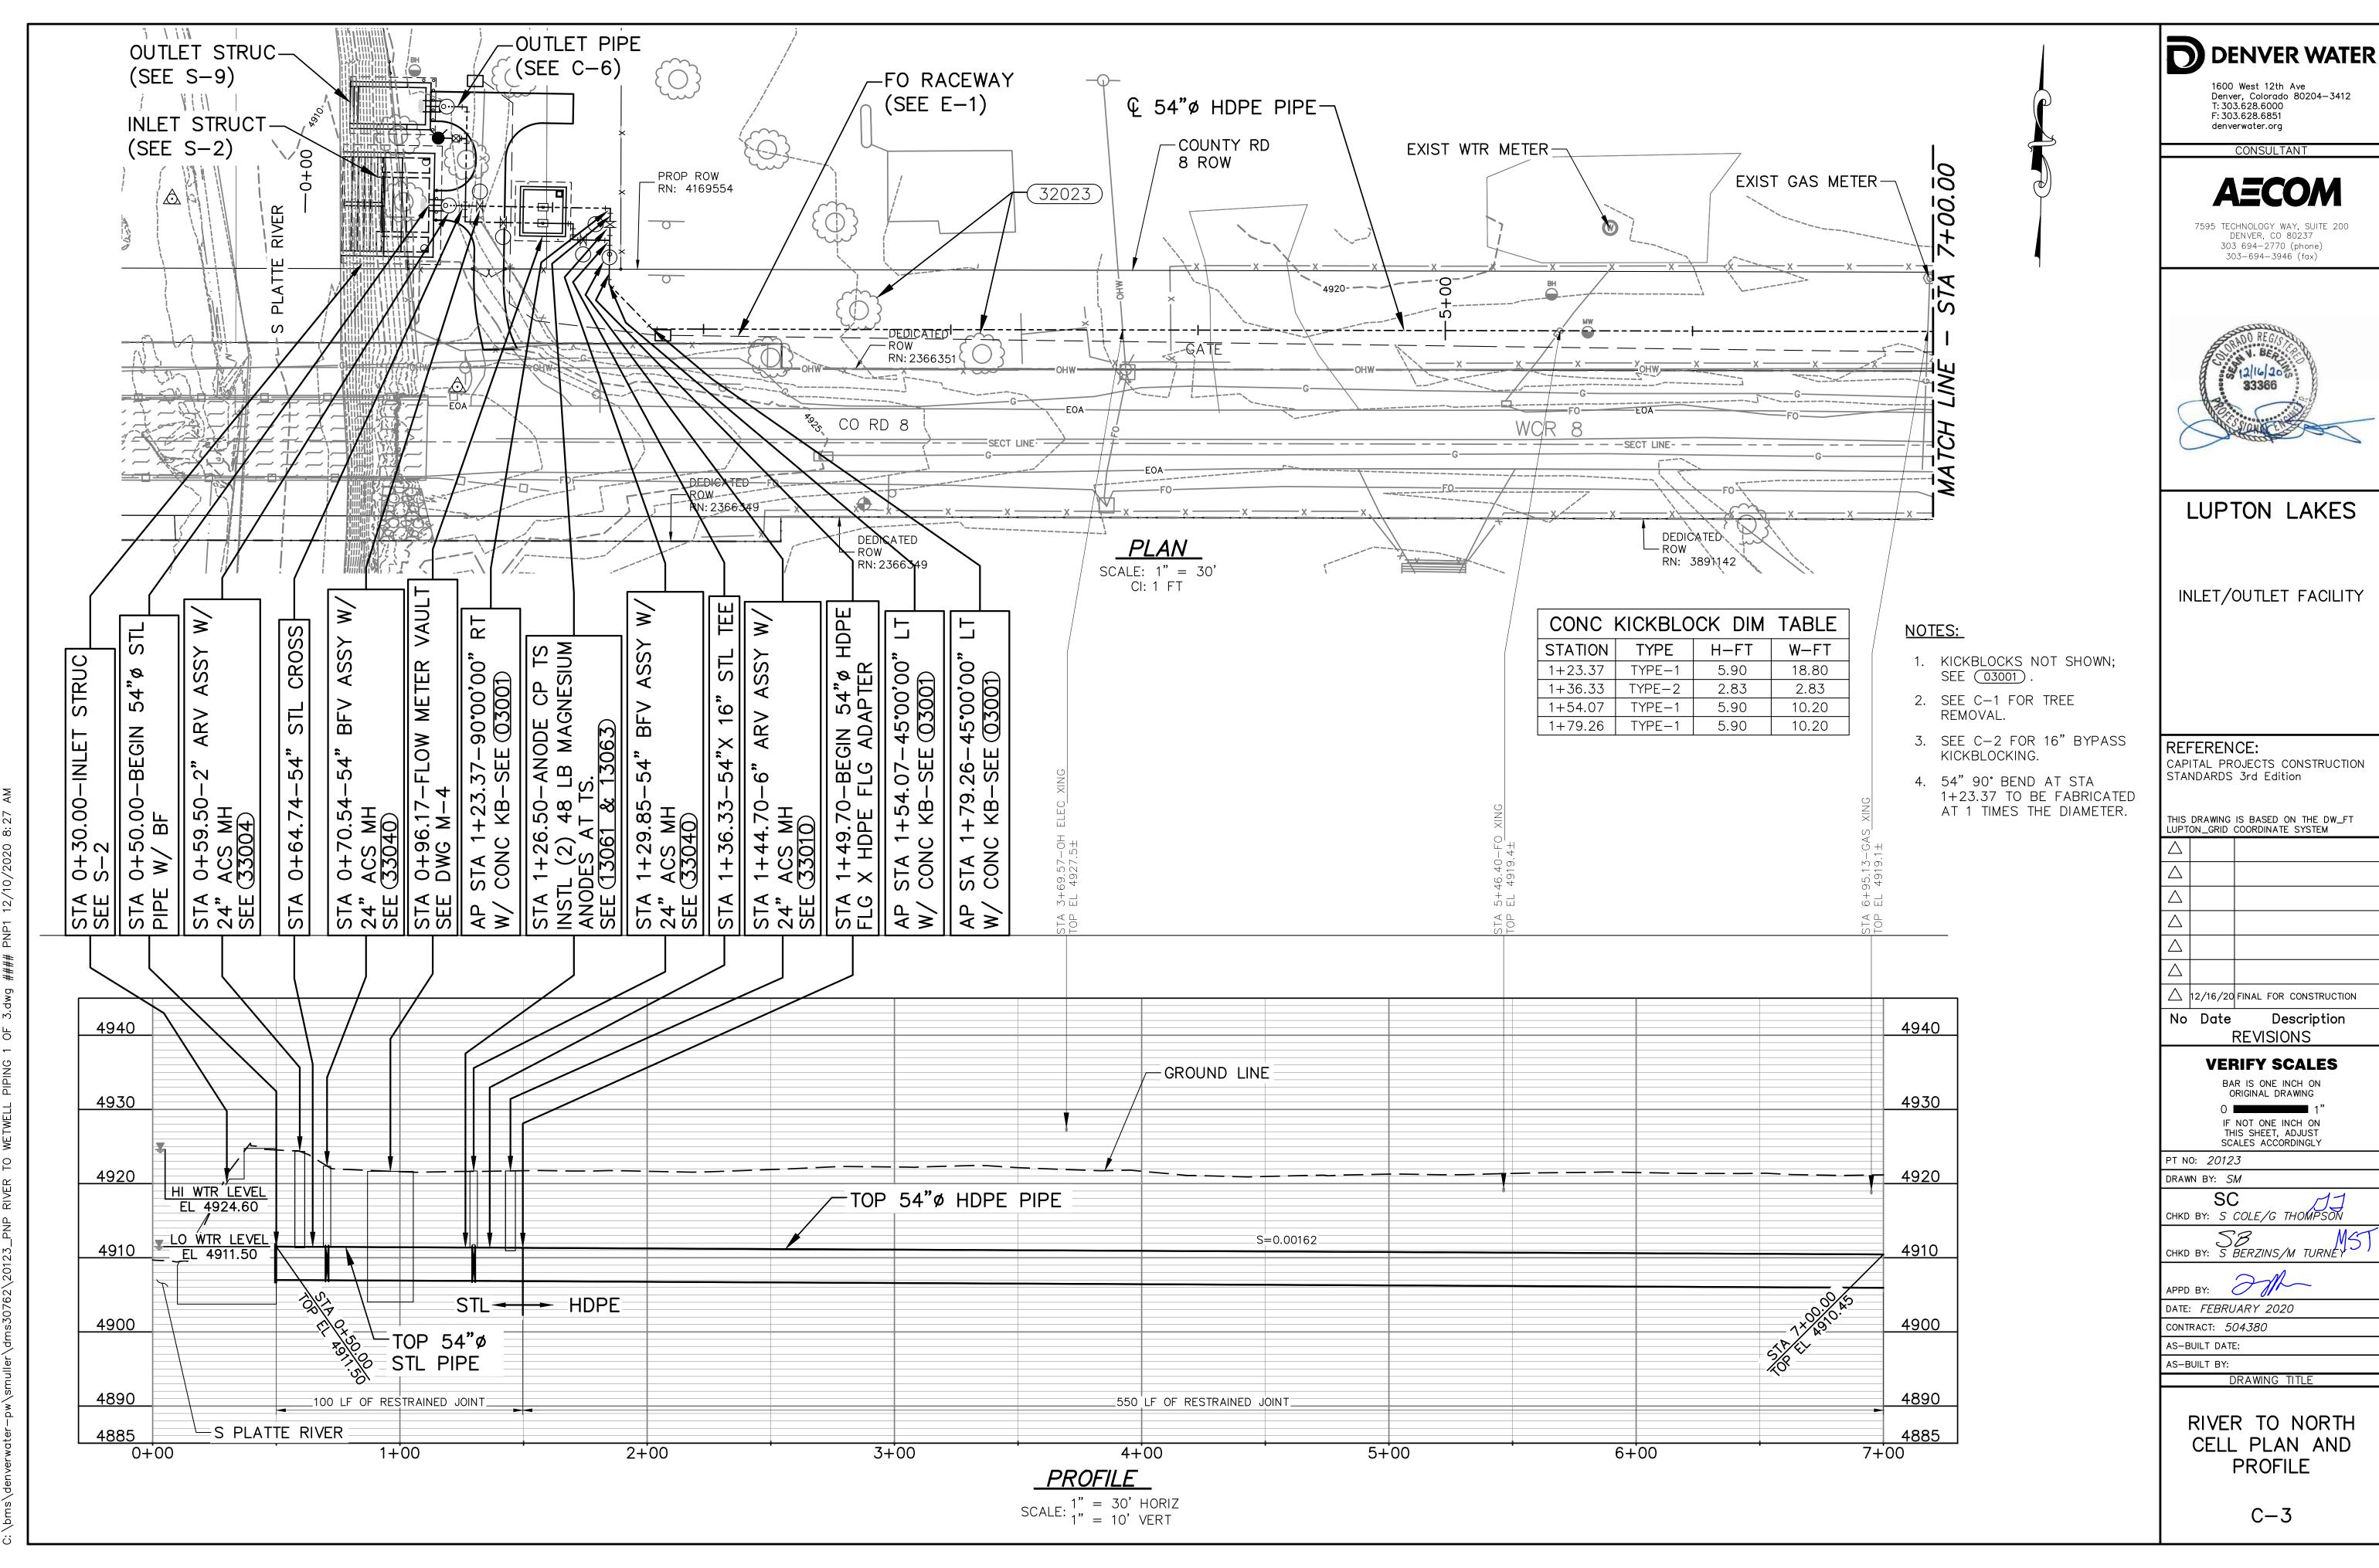

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## LUPTON LAKES

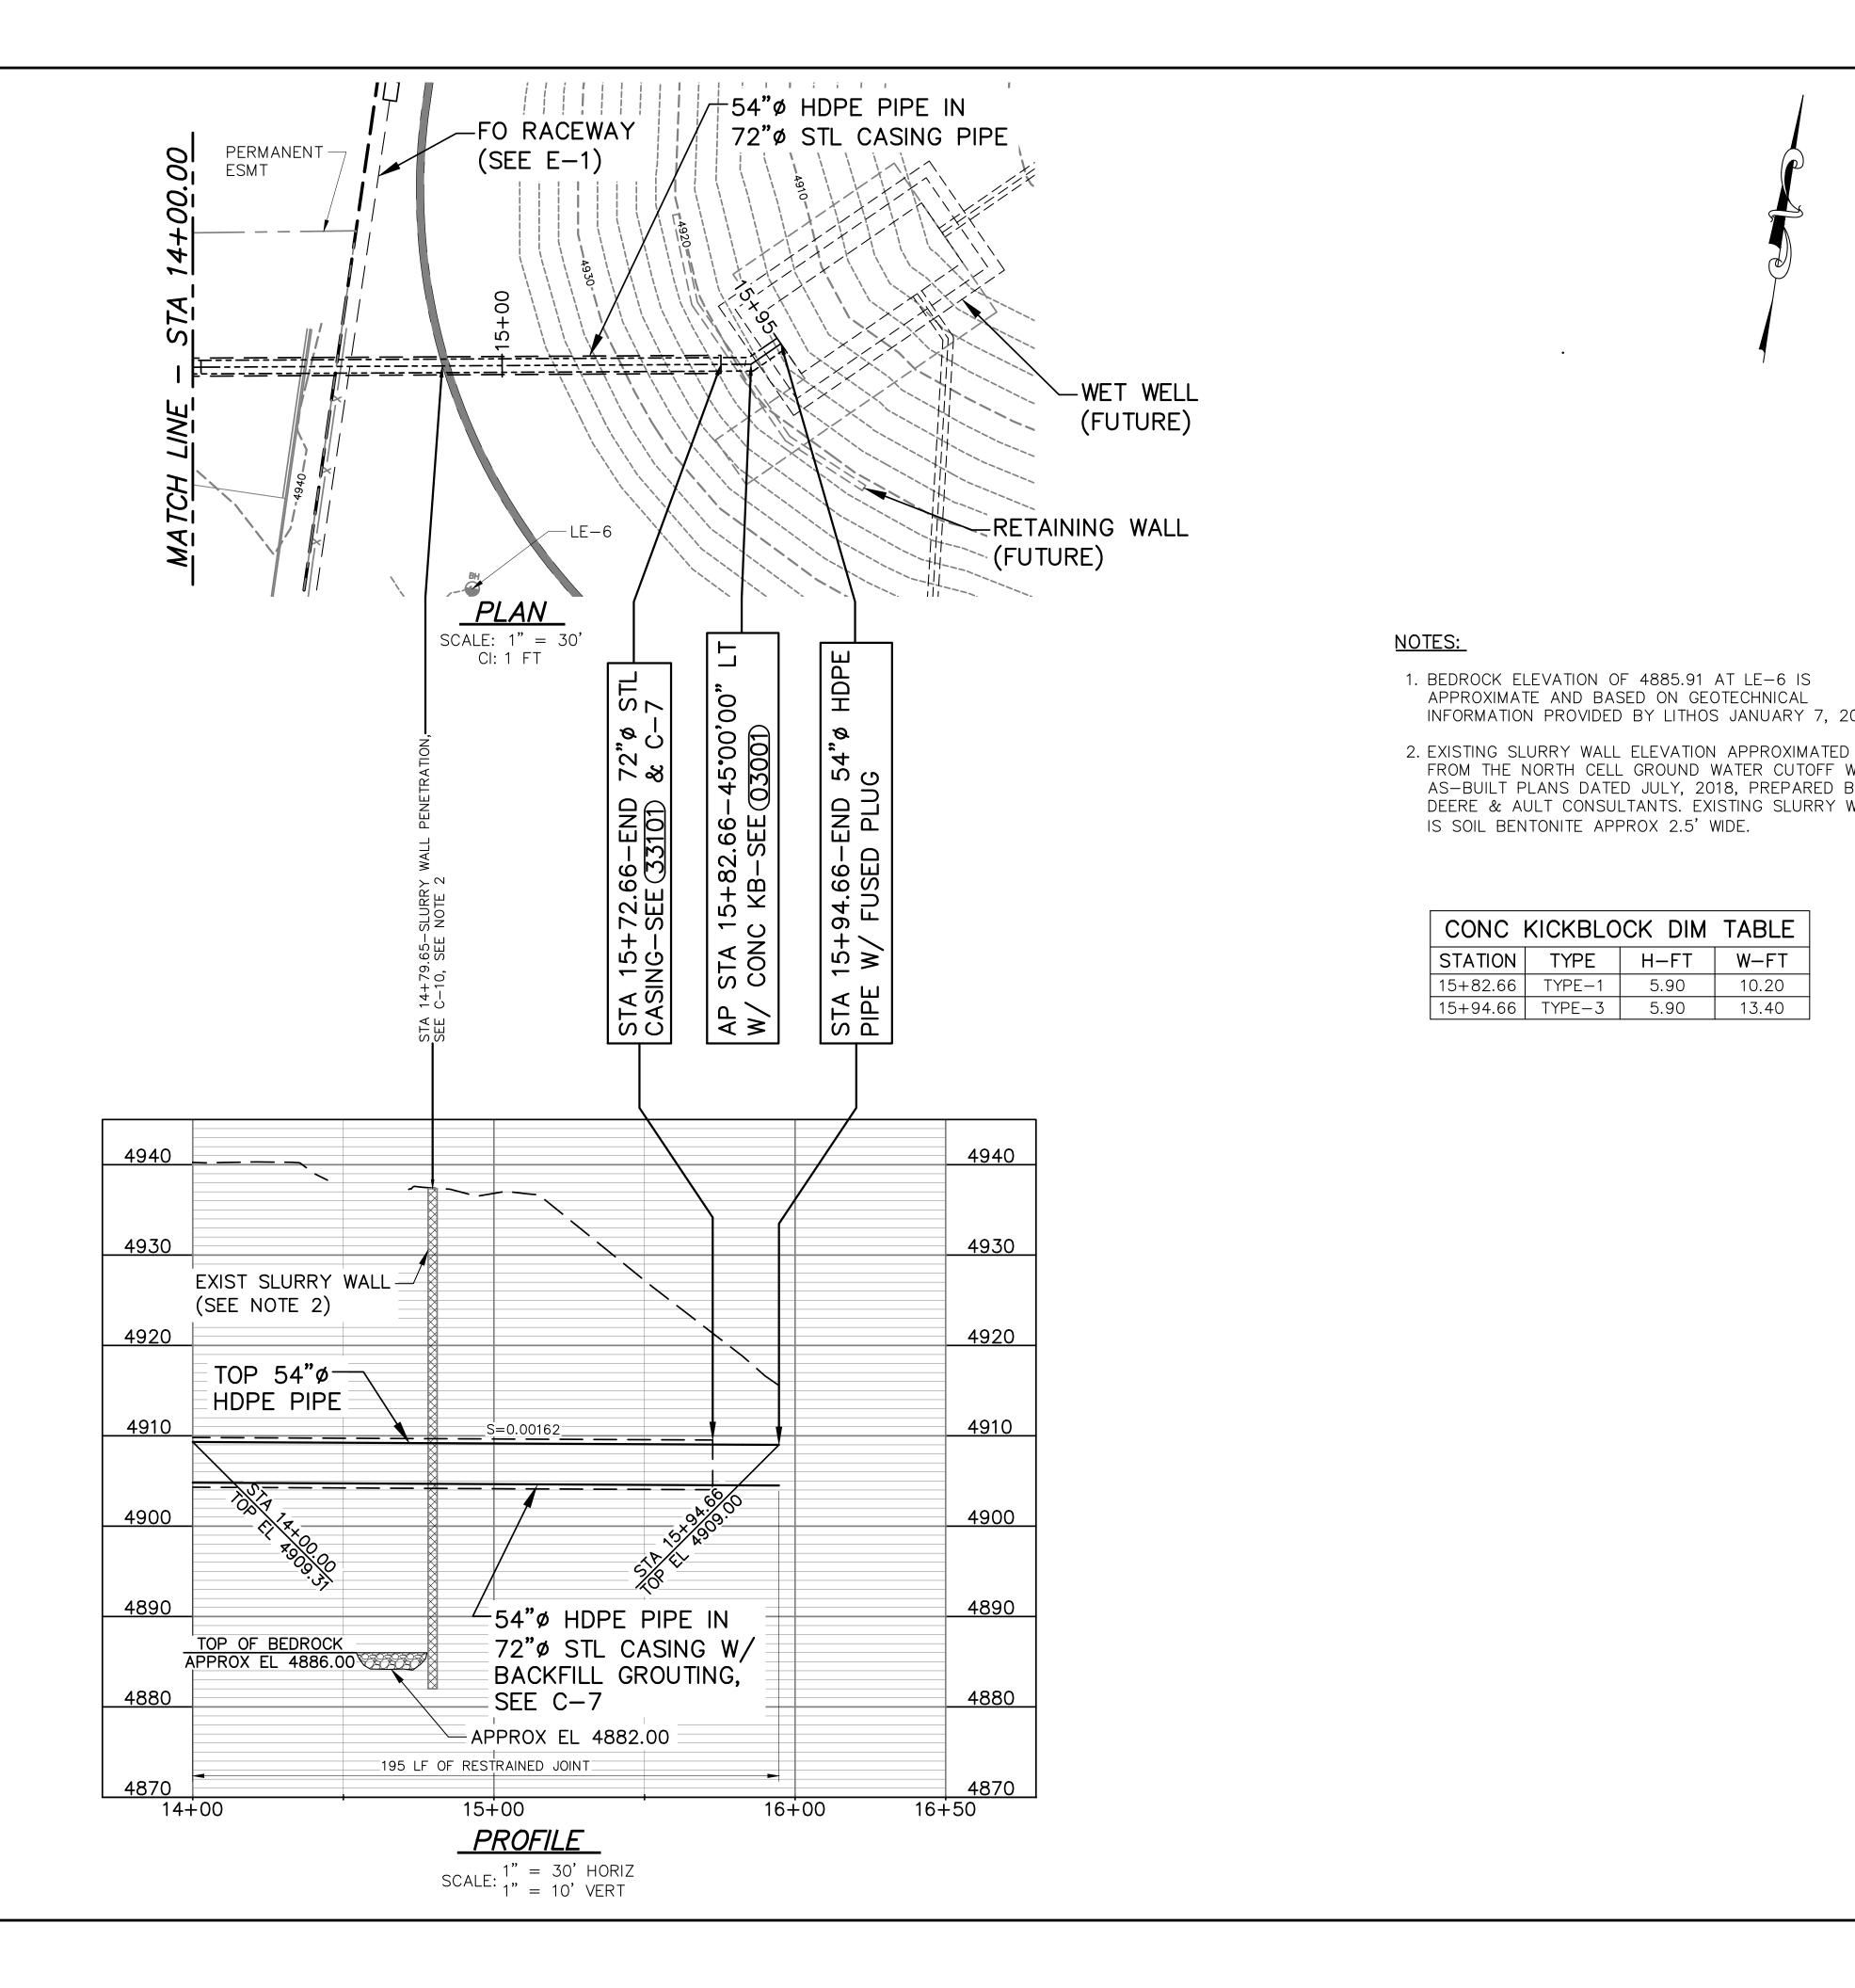INLET/OUTLET FACILITY

## REFERENCE:

APPROXIMATE AND BASED ON GEOTECHNICAL

CONC KICKBLOCK DIM TABLE

IS SOIL BENTONITE APPROX 2.5' WIDE.

STATION TYPE

15+82.66 TYPE-1

15+94.66 | TYPE-3 |

INFORMATION PROVIDED BY LITHOS JANUARY 7, 2020.

FROM THE NORTH CELL GROUND WATER CUTOFF WALL

H-FT

5.90

5.90

W-FT

10.20

13.40

AS-BUILT PLANS DATED JULY, 2018, PREPARED BY DEERE & AULT CONSULTANTS. EXISTING SLURRY WALL

> CAPITAL PROJECTS CONSTRUCTION STANDARDS 3rd Edition

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No Date Description REVISIONS

#### **VERIFY SCALES**

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DRAWN BY: SM SC CHKD BY: S COLE/G THOMPSON

PT NO: 20123

CHKD BY: S BERZINS/M TURNEY

DATE: FEBRUARY 2020

CONTRACT: 504380 AS-BUILT DATE:

AS-BUILT BY: DRAWING TITLE

RIVER TO NORTH

CELL PLAN AND PROFILE

C-5